

REQ'D

## GENERAL NOTES

- 1. ALL CONSTRUCTION MATERIALS & WORKMANSHIP TO BE IN ACCORDANCE WITH THE CURRENT EDITION OF THE B.C. BUILDING CODE PLUMBING CODE, ELECTRICAL CODE, AND ALL OTHER CODES, ZONING, AND BYLAWS THAT MAY APPLY.
- 2. THE CONTRACTOR AND ALL SUB-TRADES ARE RESPONSIBLE FOR THE REVIEW OF ALL DRAWINGS AND SITE CONDITIONS PRIOR TO COMMENCING WORK OR ORDERING ANY MATERIAL, AND SHALL REPORT AND DISCREPANCIES THAT AFFECT DESIGN TO WOOD CREEK IMMEDIATELY
- 3. ALL FRAMING MATERIAL TO BE S.P.F. #2 OR BETTER WITH THE **EXCEPTION OF WALL STUDS**
- CONCRETE FOOTINGS AND WALLS TO BE A MINIMUM 28MPA @28 DAYS. FLOOR SLABS AND SIDEWALKS TO BE MINIMUM 32MPA @ 28
- 5. ALL CONCRETE FOOTINGS TO BE PLACED ON ORIGINAL UNDISTURBED GROUND, FREE OF ALL ORGANIC, FROZEN OR FROSTY MATERIAL
- 6. DAMP PROOF FOUNDATION WALLS BELOW GRADE WITH 2 COATS OF BITUMINOUS MATERIAL.
- 7. 6 MIL. ULTRAVIOLET RESISTANT POLY VAPOUR BARRIER ON A.) 4" OF GRANULAR COMPACTABLE FILL UNDER EXTERIOR OR GARAGE SLABS. OR B.) 4" OF  $\frac{3}{4}$ " DRAIN ROCK OR OTHER MATERIAL SUITABLE FOR MOVEMENT OF RADON GAS UNDER INTERIOR SLABS.
- 8. ALL FOUNDATION DRAINS TO BE 4" PERFORATED P.V.C. WITH FILTER CLOTH AND MINIMUM 6" DRAIN ROCK, DRAINED TO MUNICPAL SERVICES ACCORDING TO LOCAL STANDARDS.
- 9. GRADE TO BE SLOPED AWAY FROM BUILDING AT ALL LOCATIONS ADJACENT TO BUILDING.
- 10. ALL TRUSSES I-JOISTS, BEAMS OR OTHER STRUCTURAL MEMBERS NOT COVERED IN B.C. BUILDING CODE TO BE DESIGNED AND ENGINEERED BY TRUSS MANUFACTURER OR STRUCTURAL ENGINEER PRIOR TO ANY FABRICATION.
- 11. CONTRACTOR TO VERIFY ALL PROPERTY AND FOUNDATION LINES WITH A LEGAL LAND SURVEYOR PRIOR TO PLACING FOOTINGS OR RUNNING SERVICES WITHIN BUILDING ENVELOPE.
- 12. ALL ROOF SPACES TO BE VENTILATED WITH SOFFIT AND ROOF VENTS WITH A MINIMUM DISTRIBUTION AREA OF 1/300. A MINIMUM OF 25% OF VENTS TO BE LOCATED AT ROOF. MINIMUM 25% TO BE LOCATED AT SOFFIT.
- 13. DOOR FRAMES AT ENTRANCES AND EXTERIOR SPACES TO DWELLING UNITS SHALL BE SOLIDLY BLOCKED BETWEEN DOOR FRAME AND STUDS AT THE HEIGHT OF THE DEADBOLT TO RESIST SPREADING.
- 14. ALL GLASS IN DOORS, SIDELITES OR WINDOWS WITHIN 12" OF FINISHED FLOOR TO BE CONSTRUCTED OF SAFETY GLASS.
- 15. RAIN WATER LEADERS NOT SHOWN ON PLAN . CONTRACTOR TO DETERMINE EXACT LOCATION SUITABLE TO SITE AND MUNICIPAL DRAINAGE.
- 16. ELECTRICAL LOCATIONS TO BE DETERMINED BY ELECTRICAL CONTRACTOR WITH THE APPROVAL OF THE HOME OWNER OR GENERAL CONTRACTOR AND IN ACCORDANCE WITH CURRENT ELECTRICAL CODE.
- 17. APPROVED SMOKE ALARMS TO BE INSTALLED WITH LOCATION APPROVED BY APPROPRIATE LOCAL MUNICIPALITY.
- 18. REFER TO LAOUTS AND SPECIFICATIONS FROM STRUCTURAL ENGINEER, FLOOR JOIST SUPPLIER, AND ROOF TRUSS MANUFACTURER FOR BEAM, POST, FOOTING LOCATIONS AND SIZES, ENSURE PROPER BEARING IS PROVIDED FOR ALL POINT LOADS. ANY STRUCTURAL SPECIFICATIONS SHOWN ON WOOD CREEK PLANS ARE ESTIMATES ONLY AND MAY NOT ACCURATELY REPRESENT LOADING AND SIZING, OR MAY NOT INCLUDE POINT LOADS OR STRUCTURAL MEMBERS DESIGNED BY OTHERS.

DO NOT SCALE DRAWINGS. WRITTEI

NOTE: ALL CONSTRUCTION SHALL

1	MAY 22/20	Deck revised to 12' deep
2	JUNE 26/20	WINDOW SIZE CHANGES
NO.	DATE	DESCRIPTION
REVIS	SIONS	




LEGAL DESCRIPTION

LOT 34, SEC 12, TP 20, R 10, W6M KDYD, Plan EPP69286 1181 - 17 AVE SE

**WINTERS** 

SITE PLAN & **GENEREAL** NOTES

JUNE 26/2020	SHEET NUMBER
SCALE 3/32"=1'	Λ
DRAWN PC	<i>H</i> -
CHECKED XX	

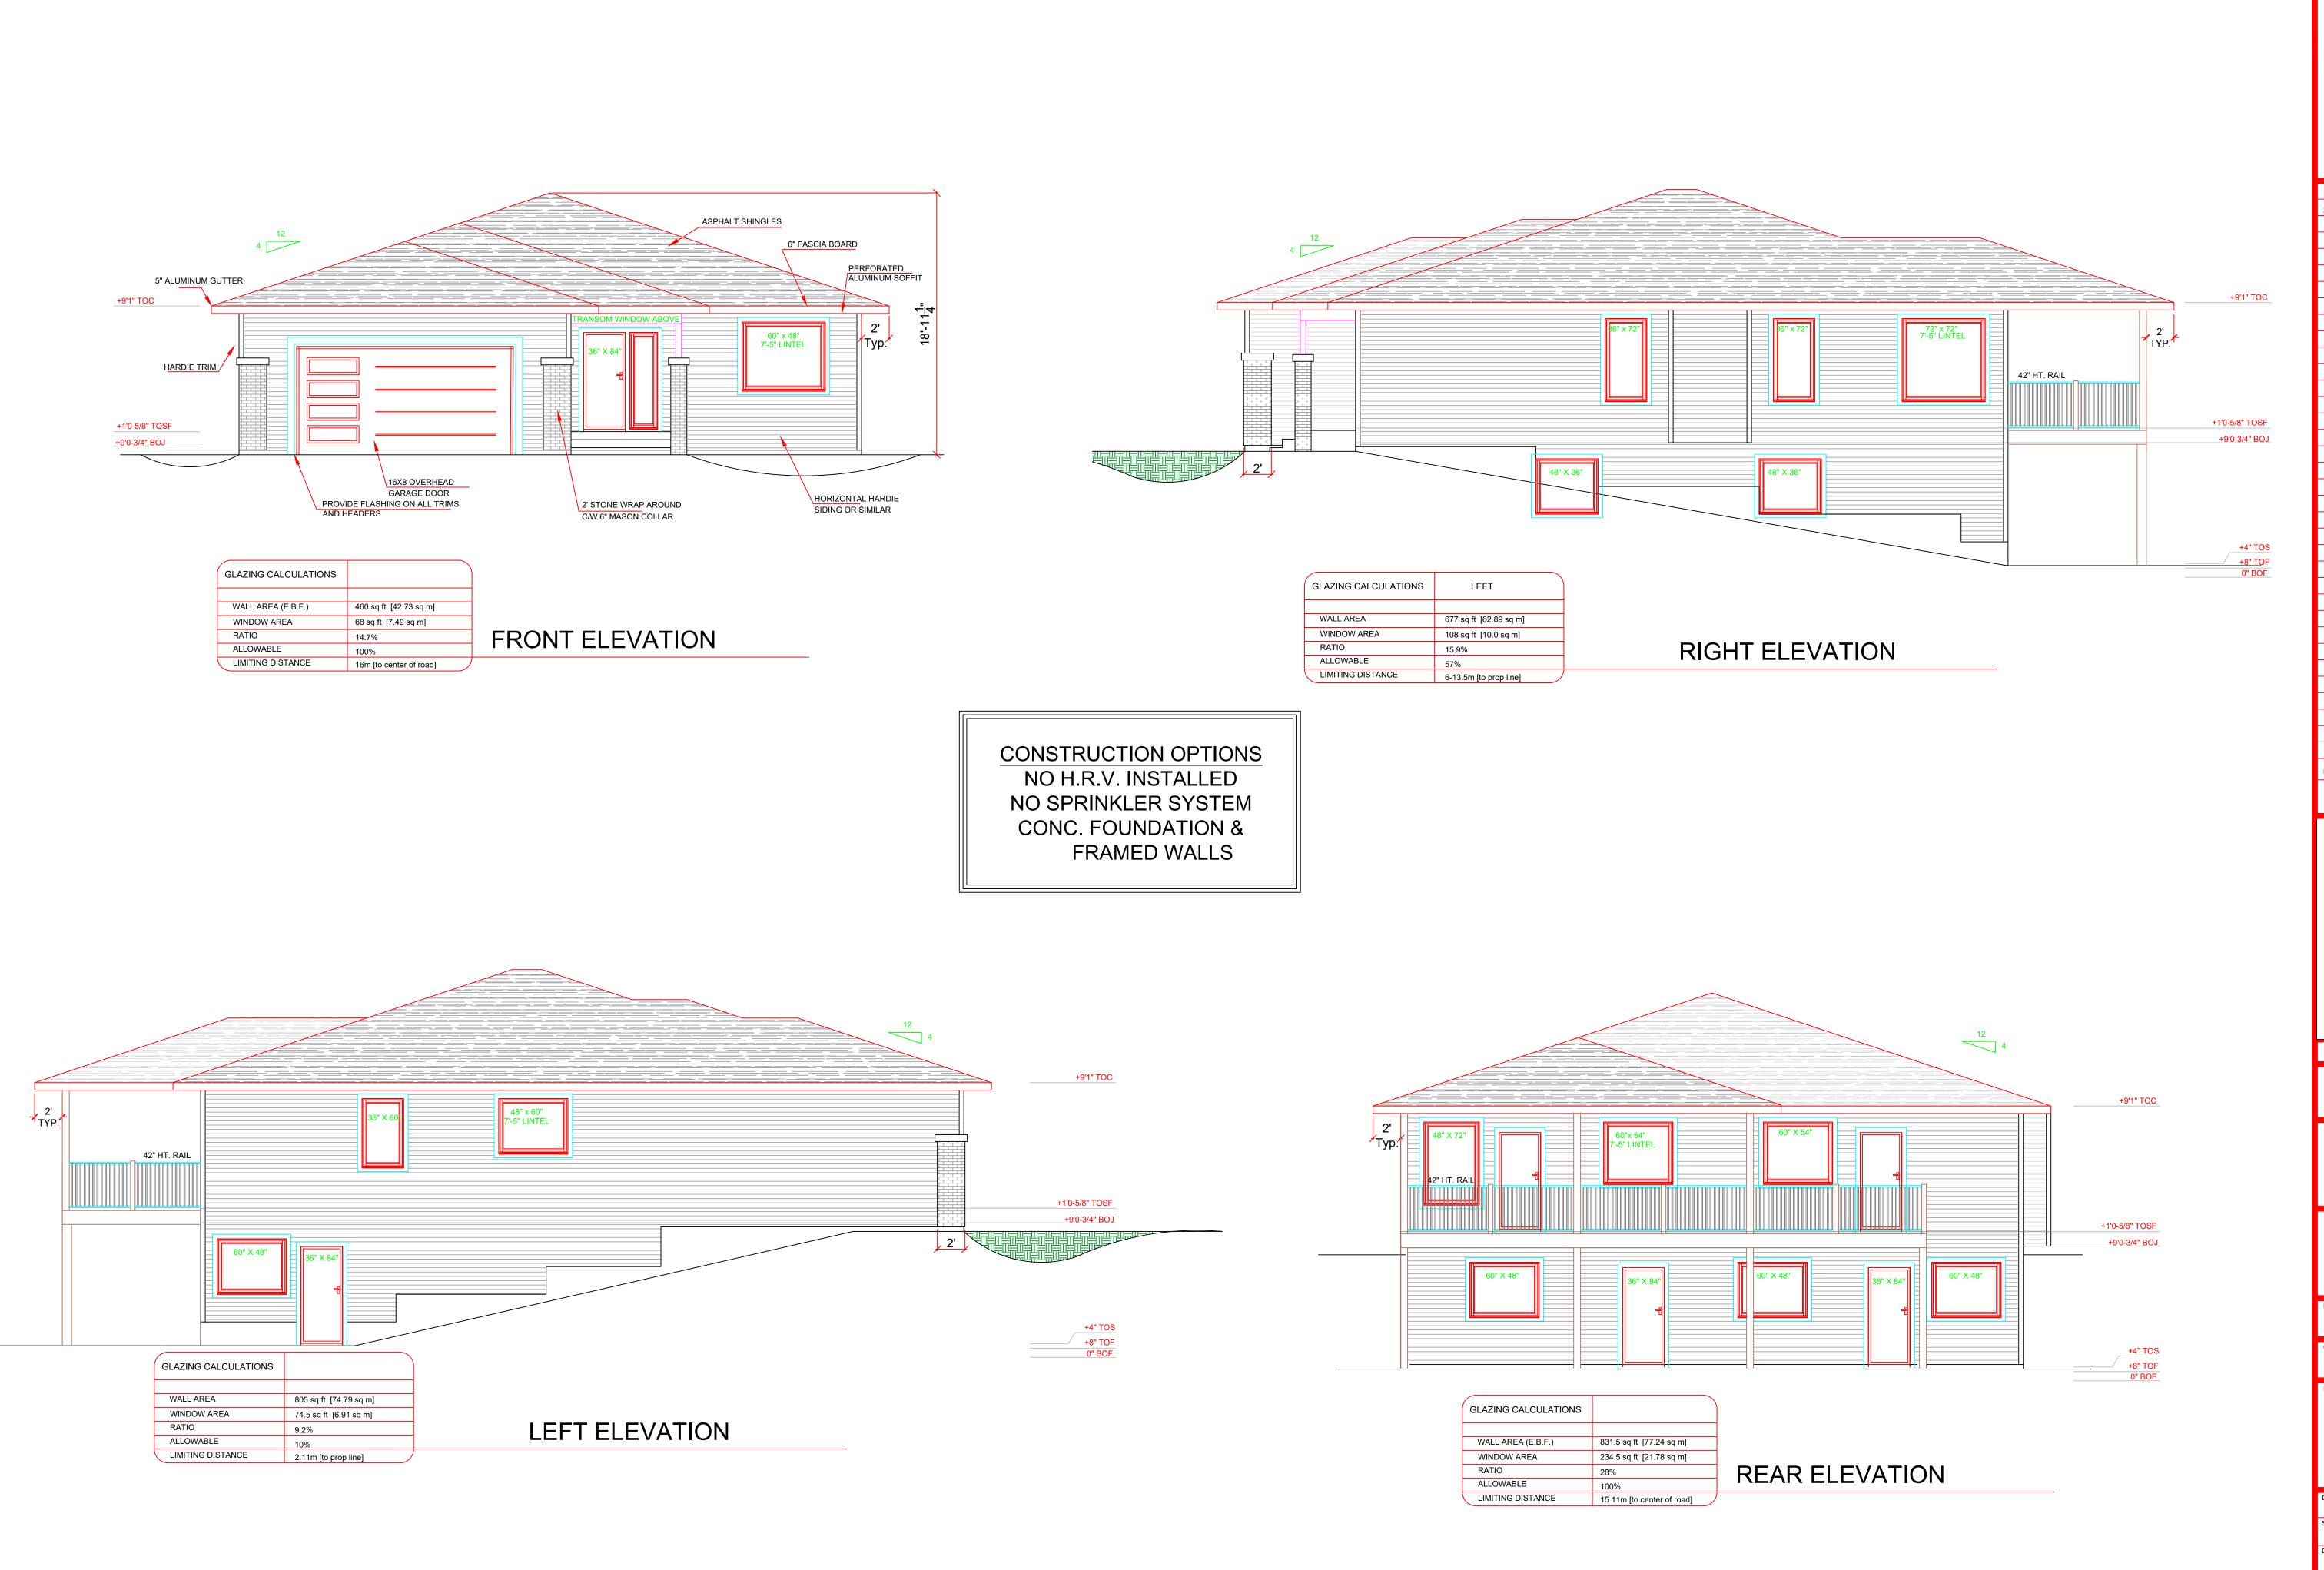

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JUNE 26/20 WINDOW SIZE CHANGES REVISIONS




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WINTERS


**ELEVATIONS** 

DATE JUNE 26/2020 3/16"=1' A-2 DRAWN PC CHECKED



## MAIN FLOOR 1717 SQ. FT.

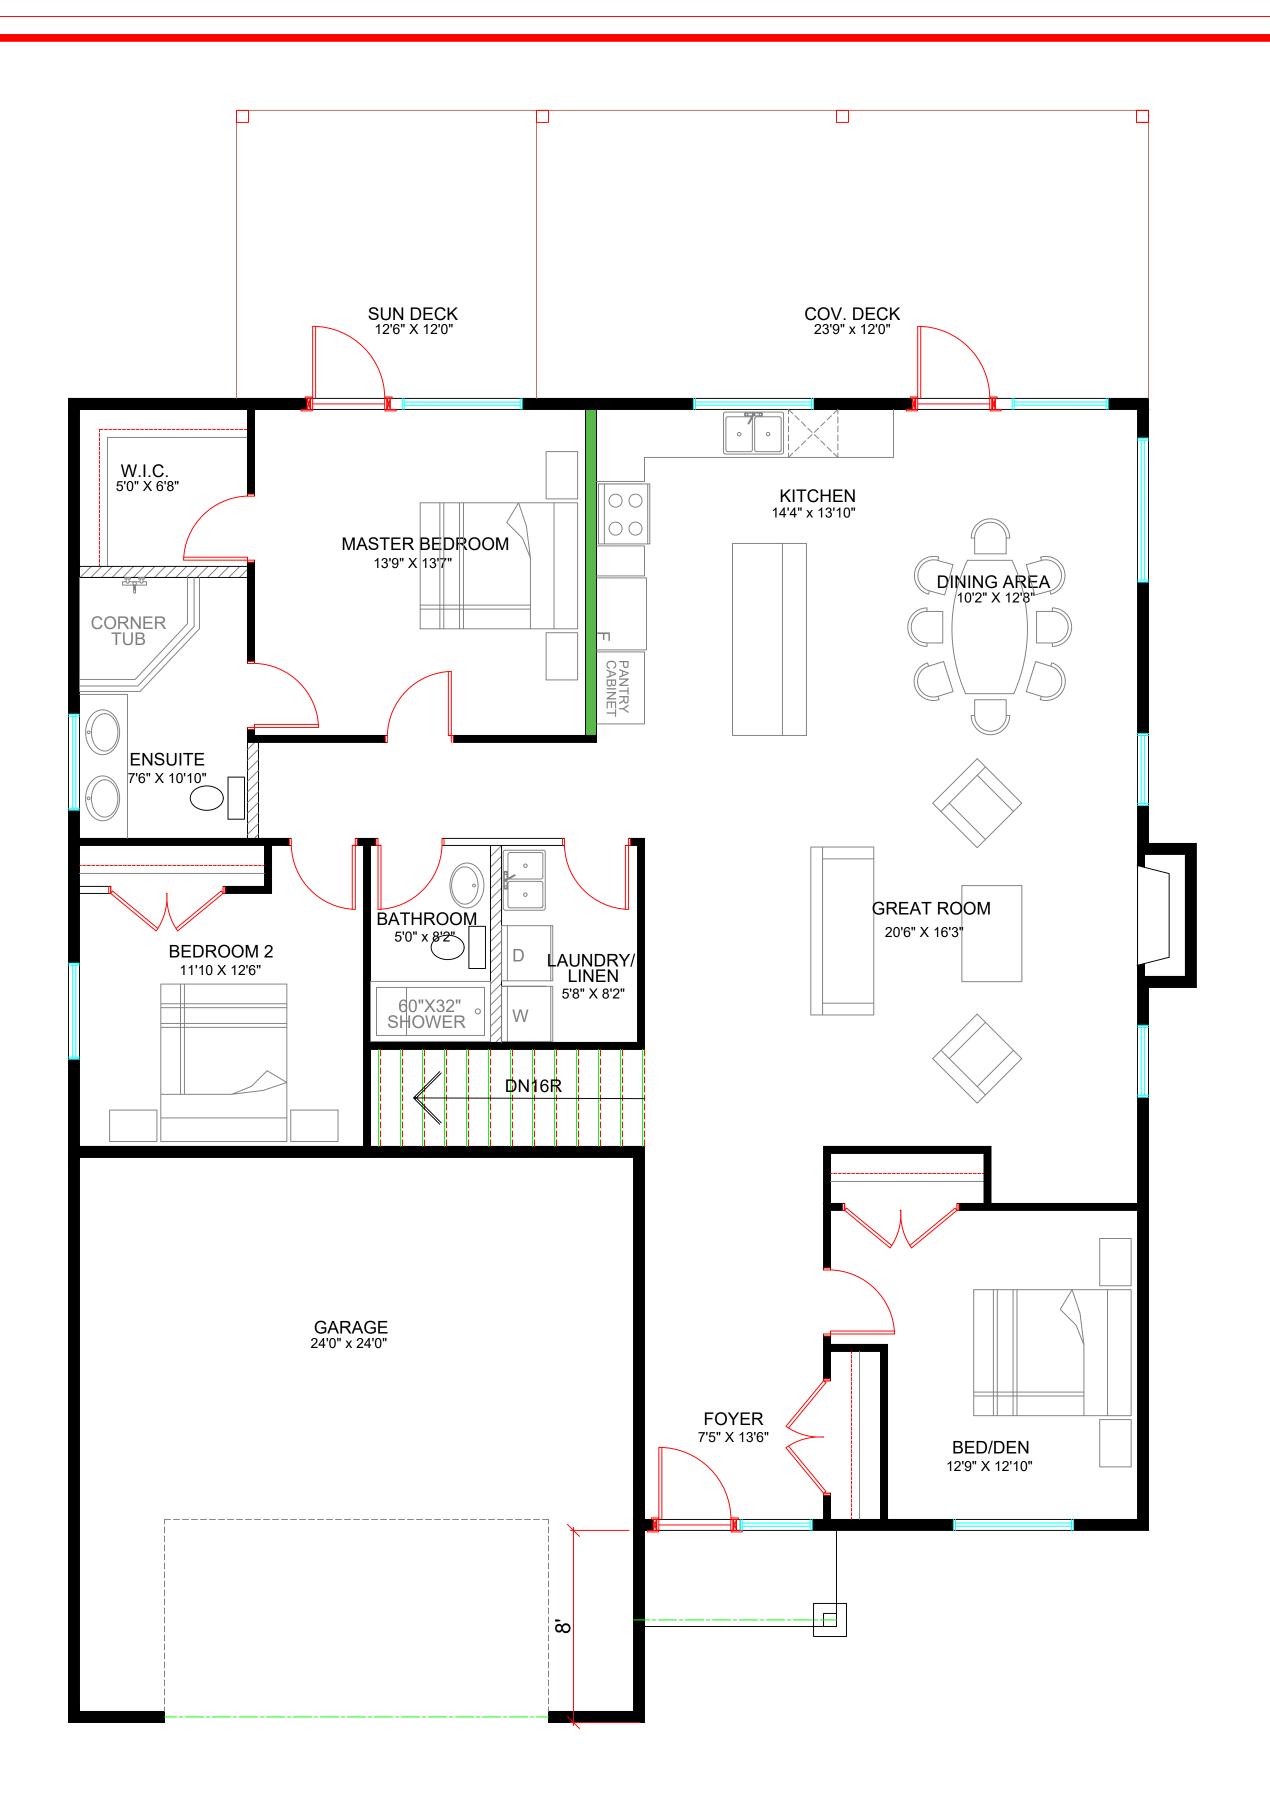Garage - 532 SQ FT.
Deck/Porch Area - 380 SQ FT.
9' Ceilings

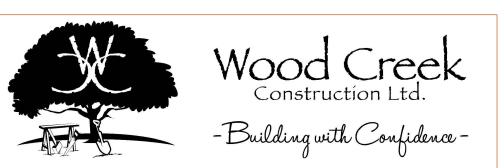

## FLOOR NOTES

SAFE & SOUND

INSULATION

PLUMB WALL

- FRAMED EXTERIOR WALLS DOES NOT INCLUDE EXTERIOR SHEATHING.
- 2. ALL DIMENSIONS SHOWN
  ARE TO FRAMING AND DO
  NOT INCLUDE DRYWALL
  OR OTHER FINISHES
- 3. 3.ALL HEADERS TO BE
  3-2X10 IN 2X6 WALLS AND
  2-2X10 IN 2X4 WALLS
  UNLESS NOTED
  OTHERWISE
- 4. ALL DOORS AND WINDOWS FRAMED 4-1/2" FROM ADJACENT WALLS UNLESS NOTED OTHERWISE
- 5. ALL DOOR SLABS TRO
  MEASURE 80" IN HEIGHT
  UNLESS OTHERWISE
  NOTED
- 6. INDIVIDUAL ROOM AREAS
  ARE CALCULATED FROM
  INSIDE OF FRAMING
  WHEREAS THE OVERALL
  FLOOR AREA IS
  CALCULATED TO OUTSIDE
  EXTERIOR WALLS

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JUNE 26/20 WINDOW SIZE CHANGES

	DATE	DESCRIPTION	
EVISIONS			



LOT 34, SEC 12, TP 20, R 10, W6M KDYD, Plan EPP69286 1181 - 17 AVE SE

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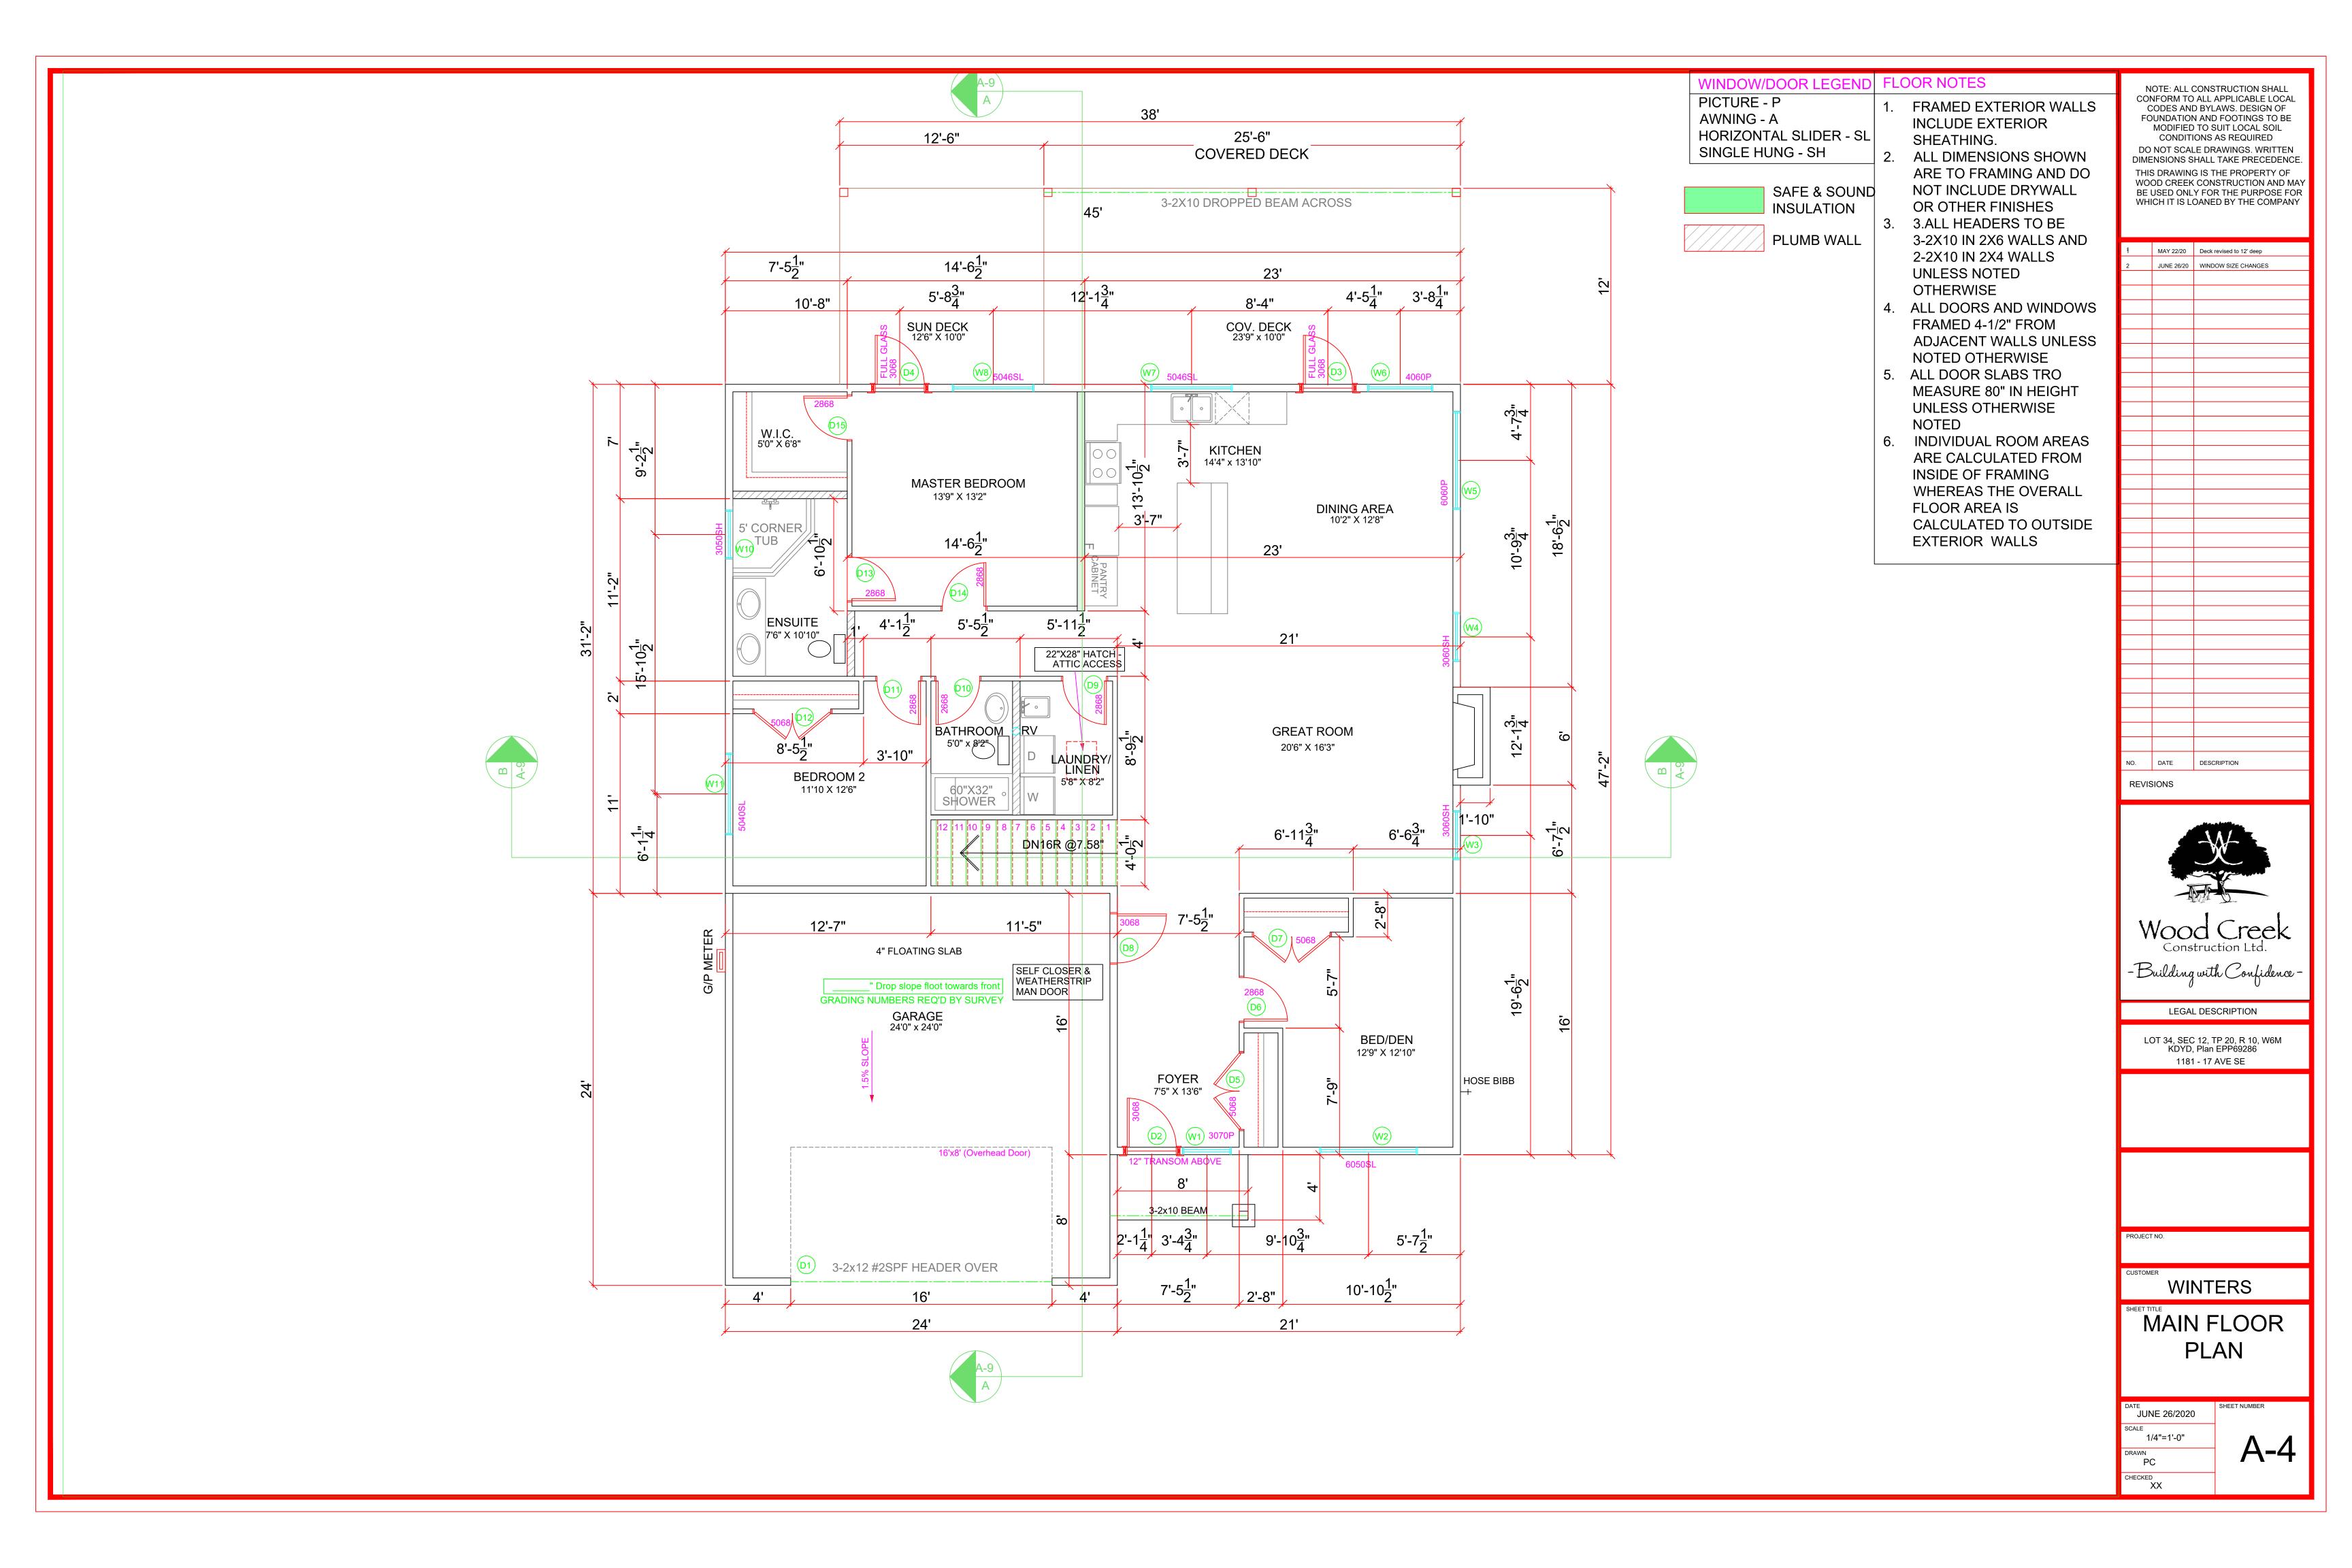
PROJECT NO


CUSTOMER WINTERS

SHEET TITLE

MAIN FLOOR LAYOUT

JUNE 26/2020	SHEET NUMBER
1/4"=1'	۸ ၁
PC	A-3
CHECKED	



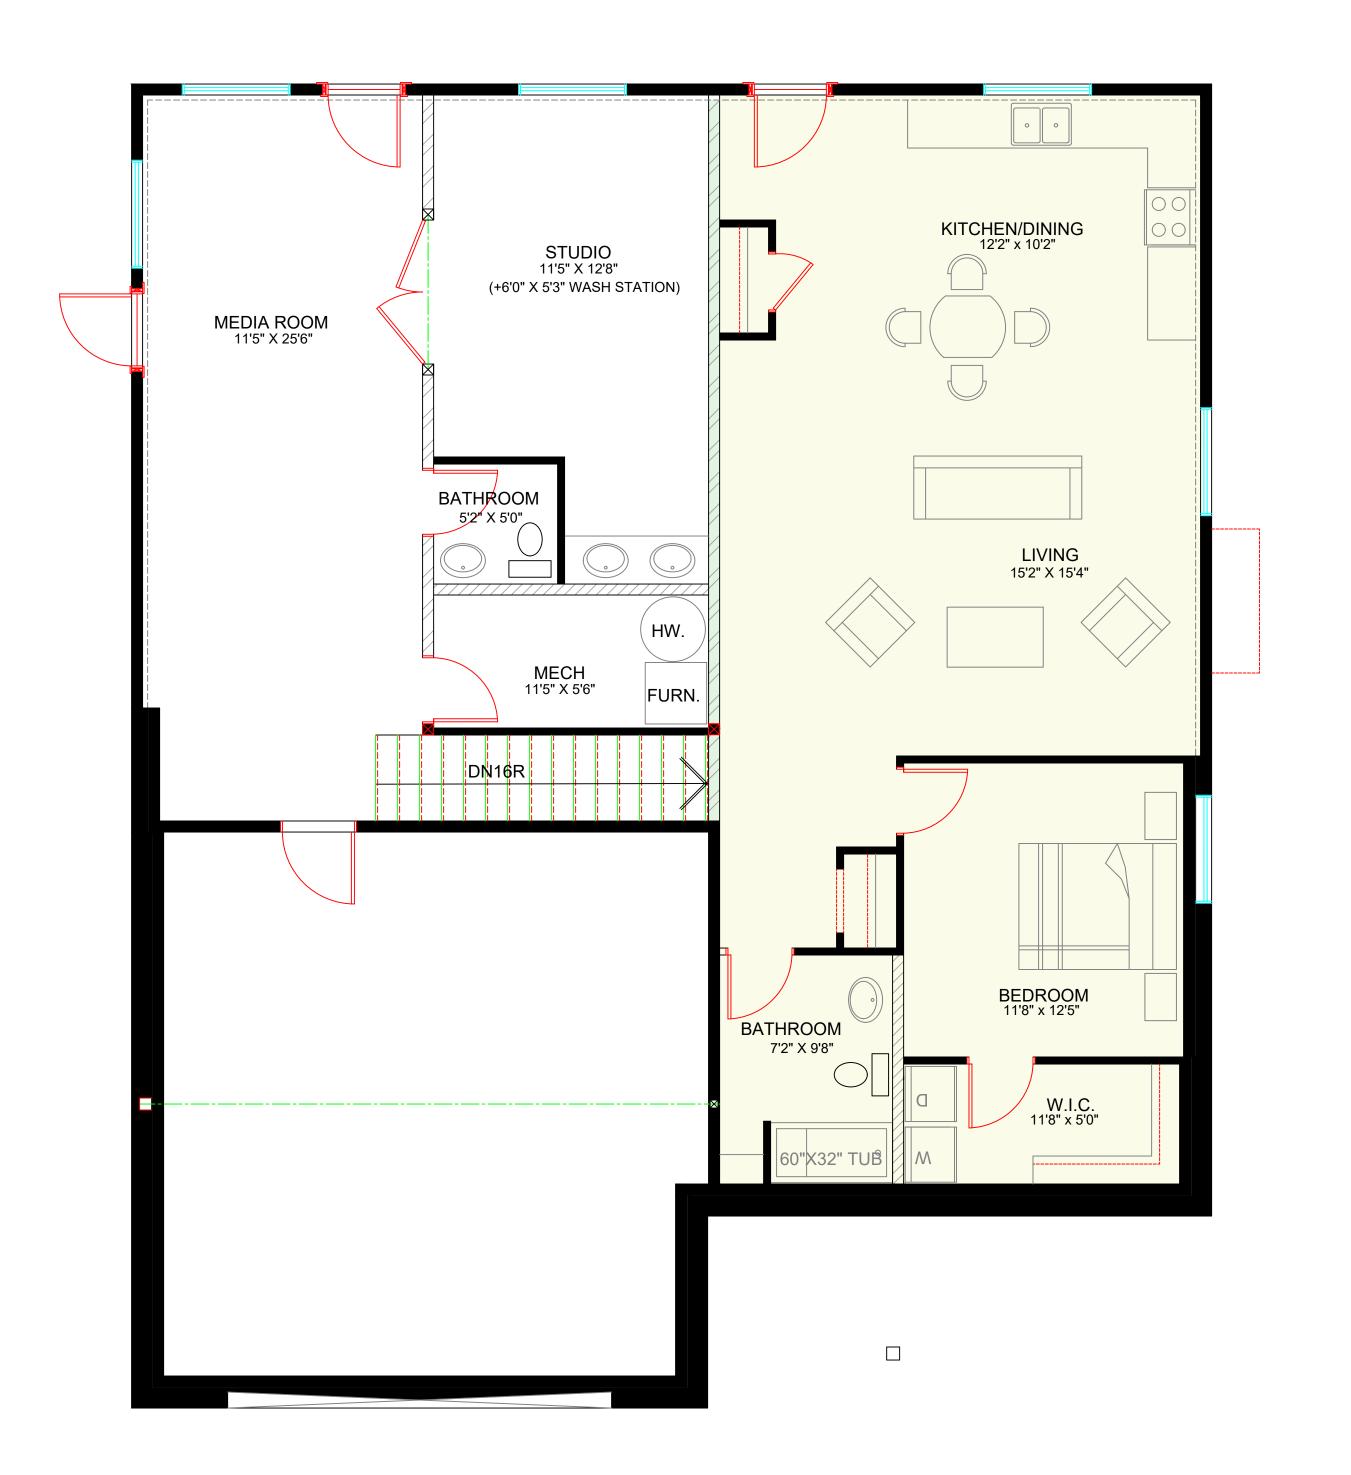

DEV. BASEMENT 1573 SQ. FT.

Suite - 900 SQ FT. 9' Ceilings





## FLOOR NOTES

SAFE & SOUND

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L.B. WALL

SUITE

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REVISIONS


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WINTERS


BASEMENT **PLAN** 


DATE JUNE 26/2020 A-5





LOOR NOTES

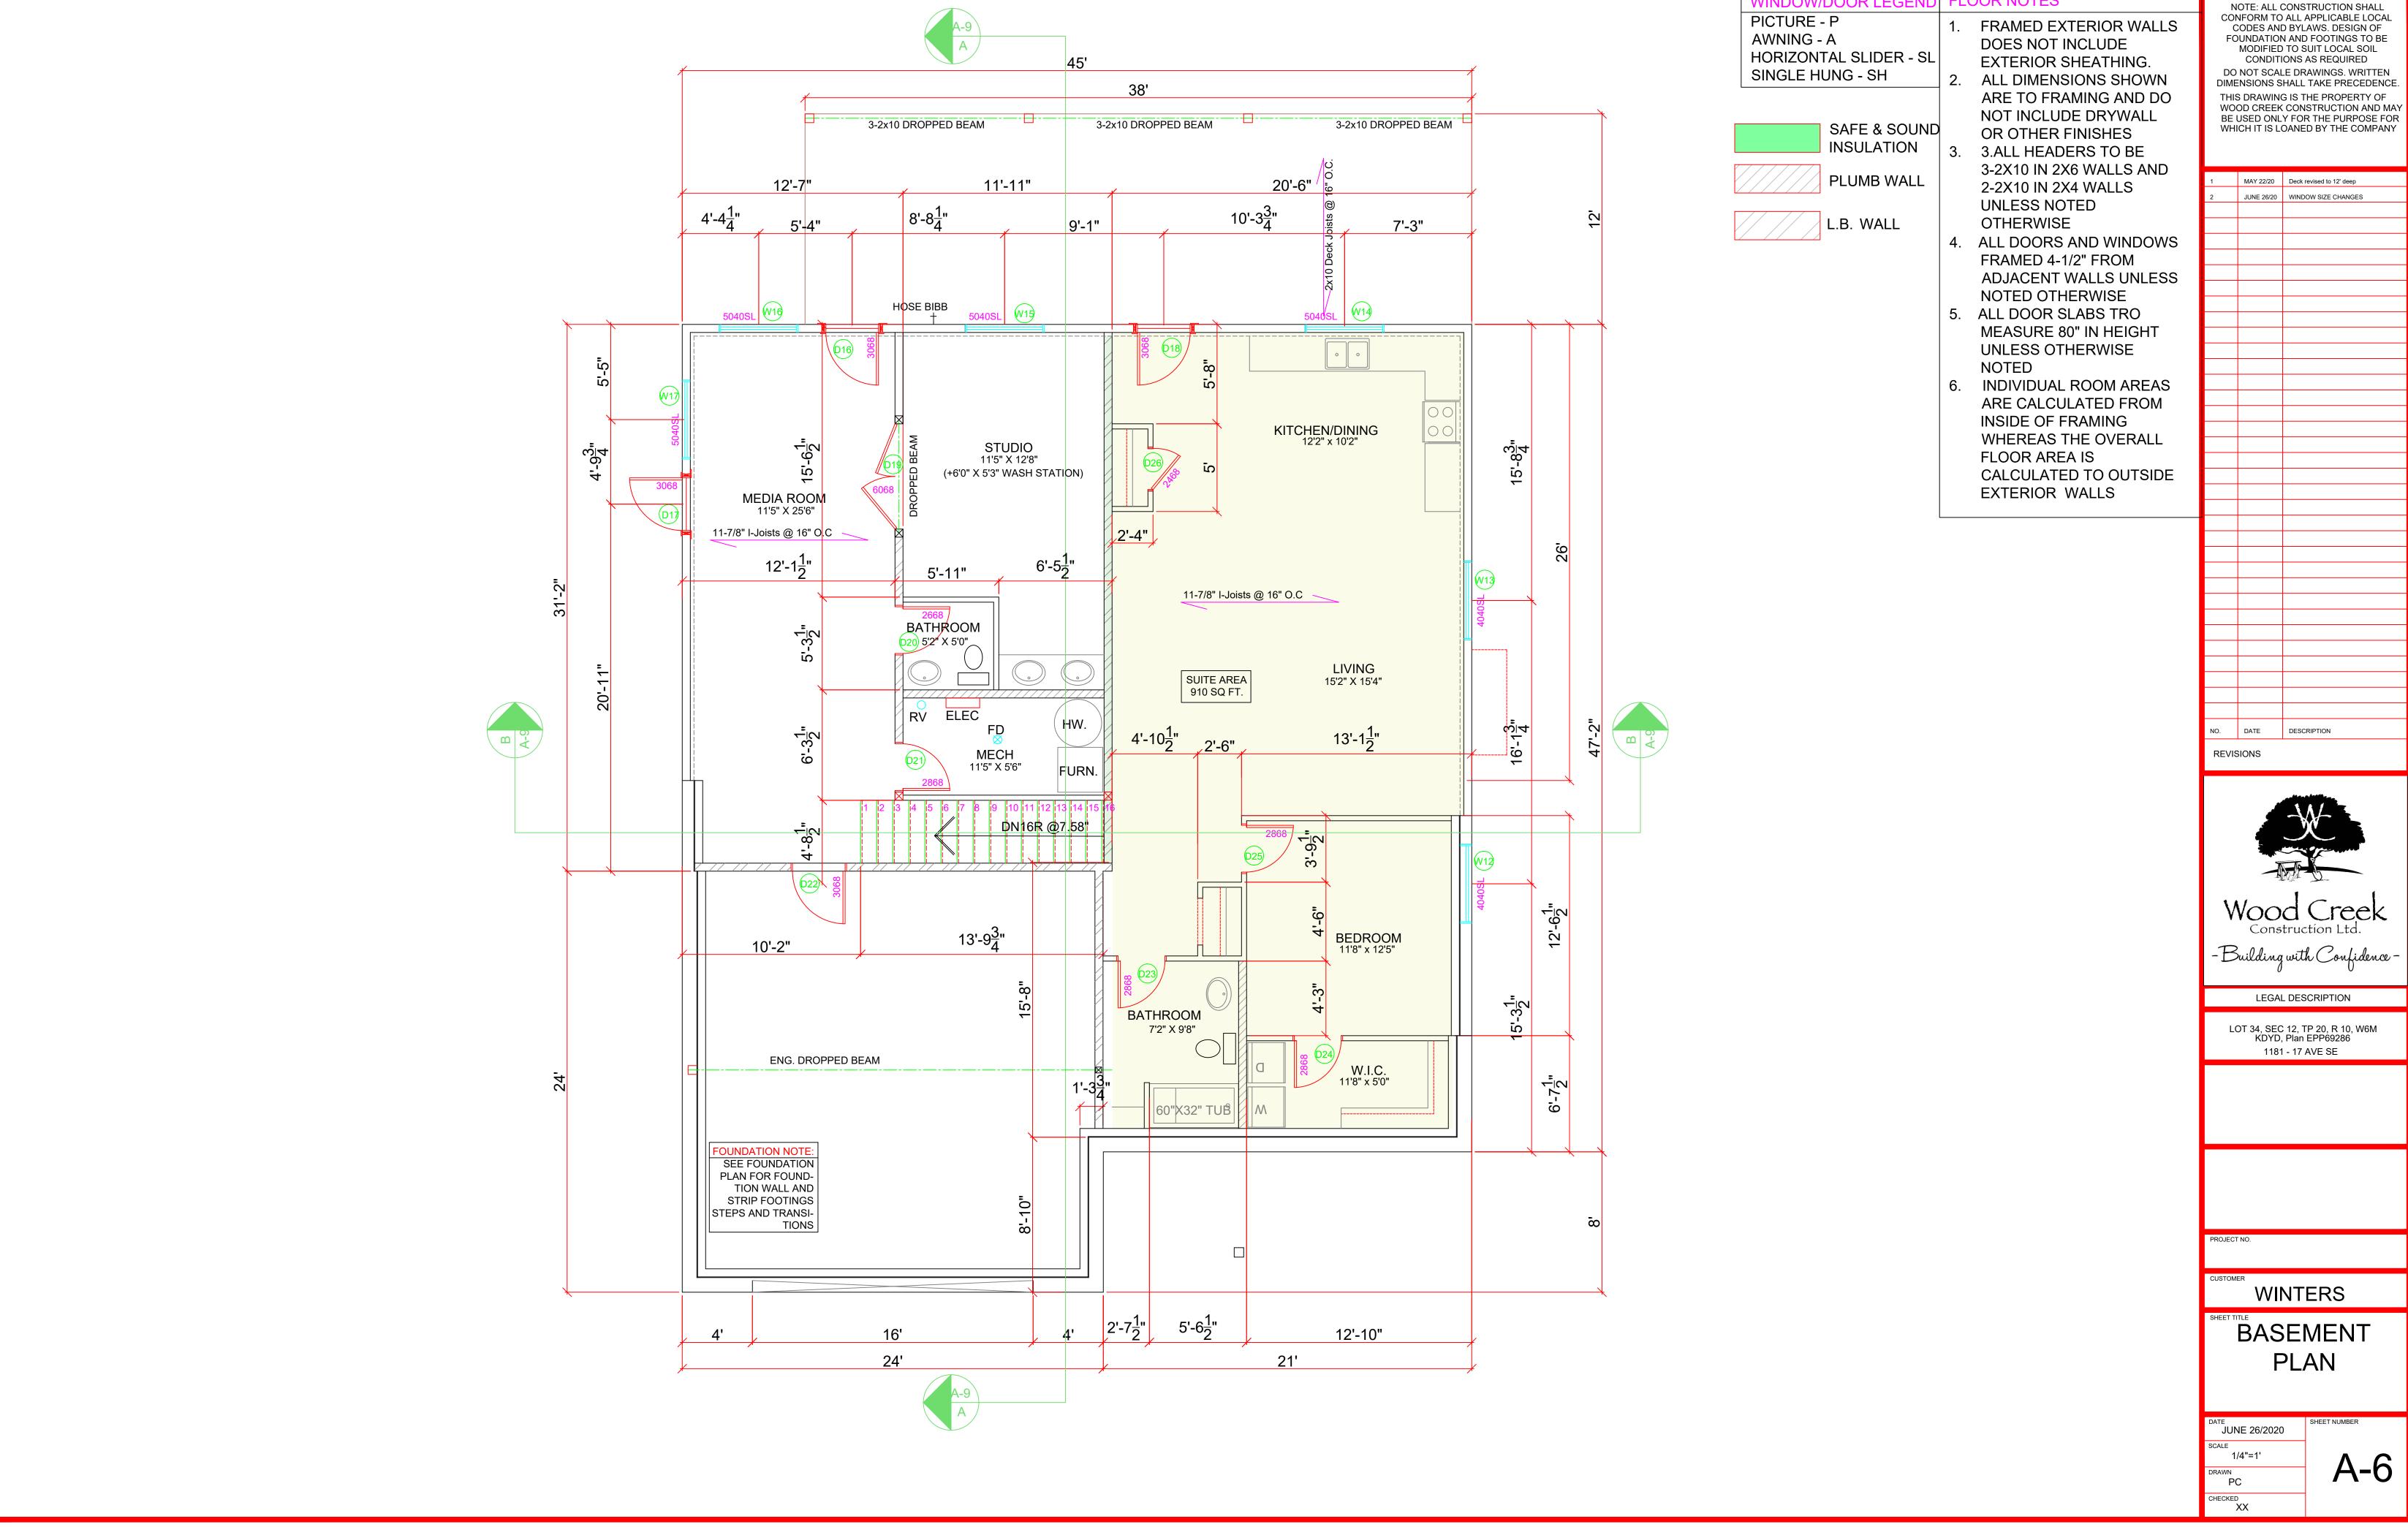DATE	DESCRIPTION

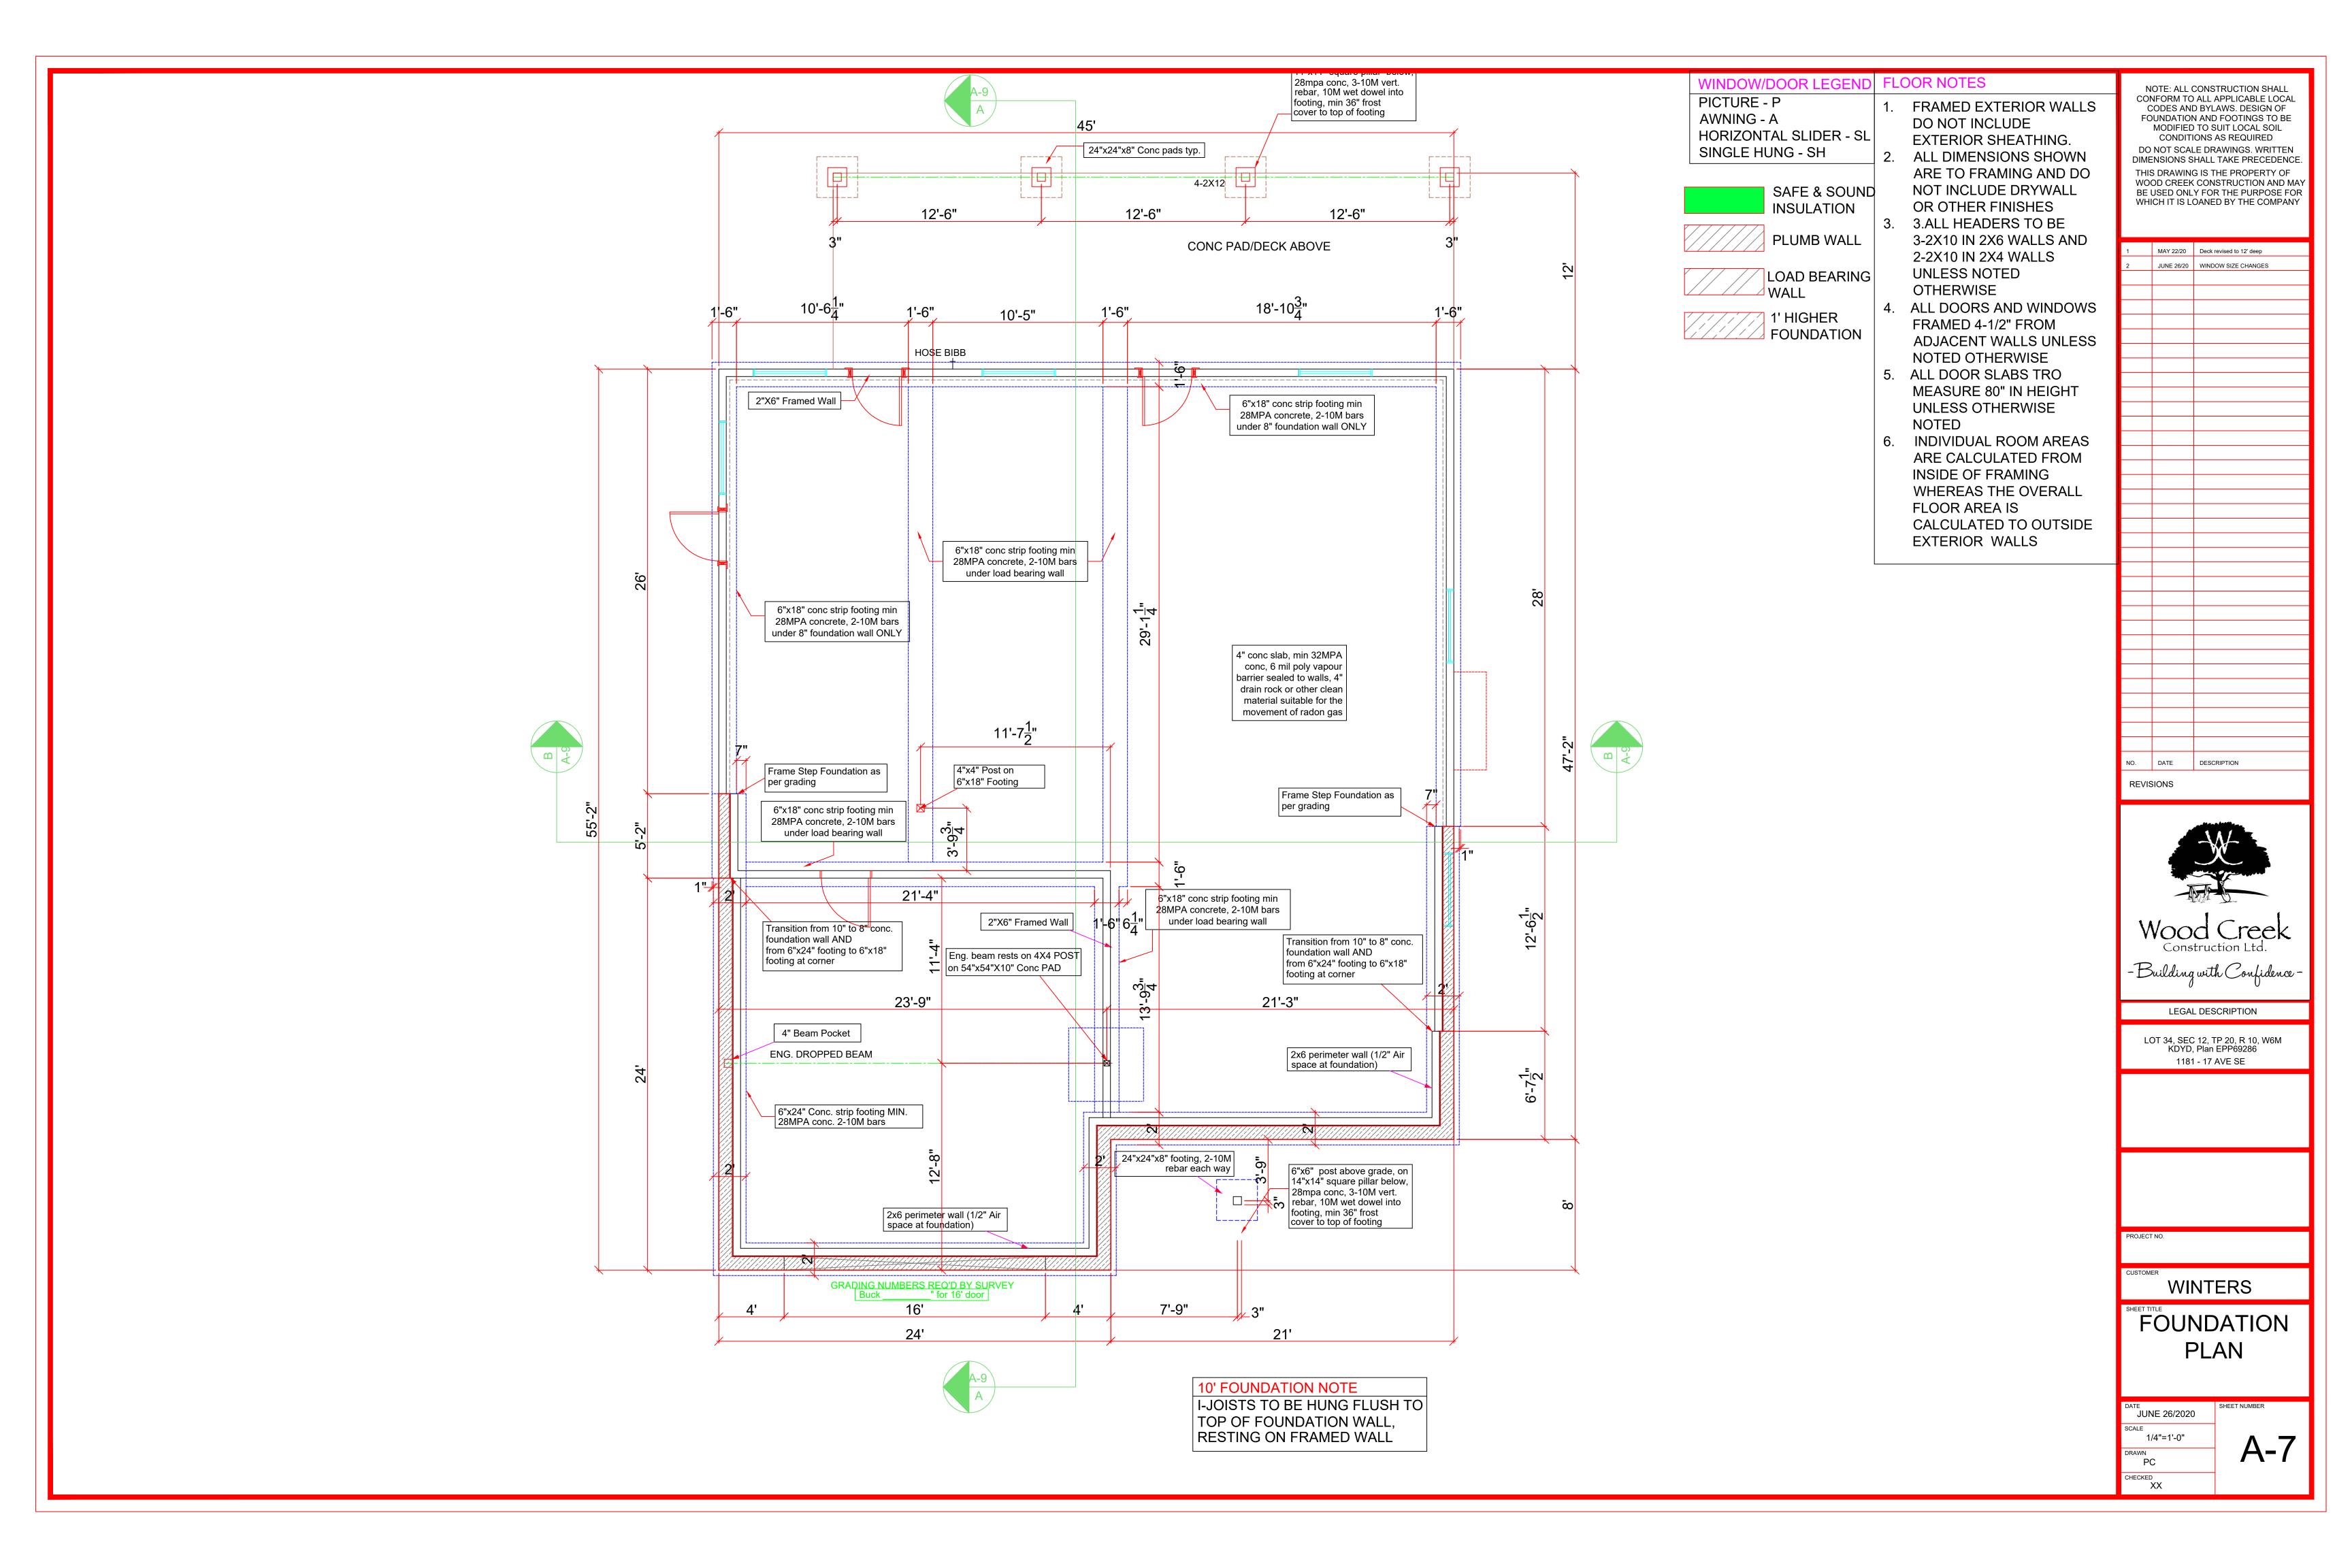

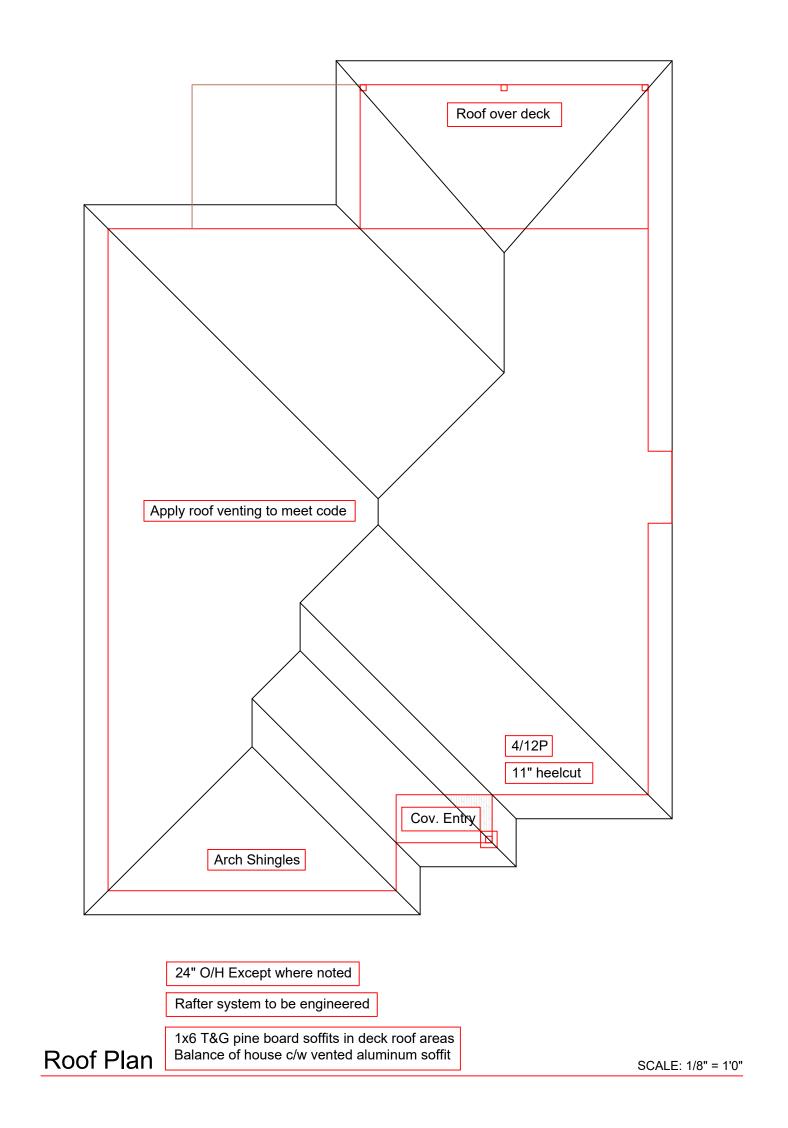

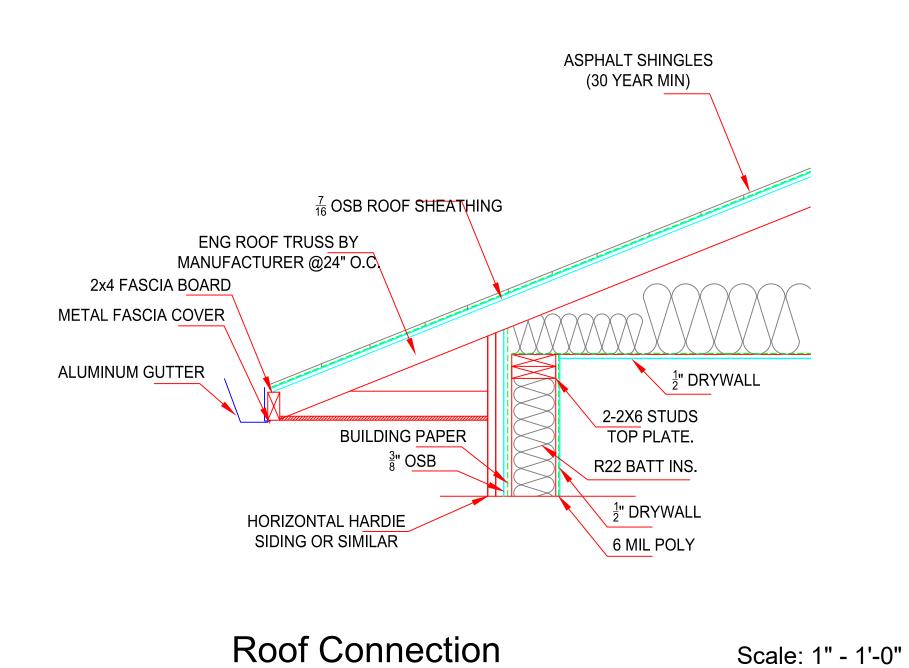

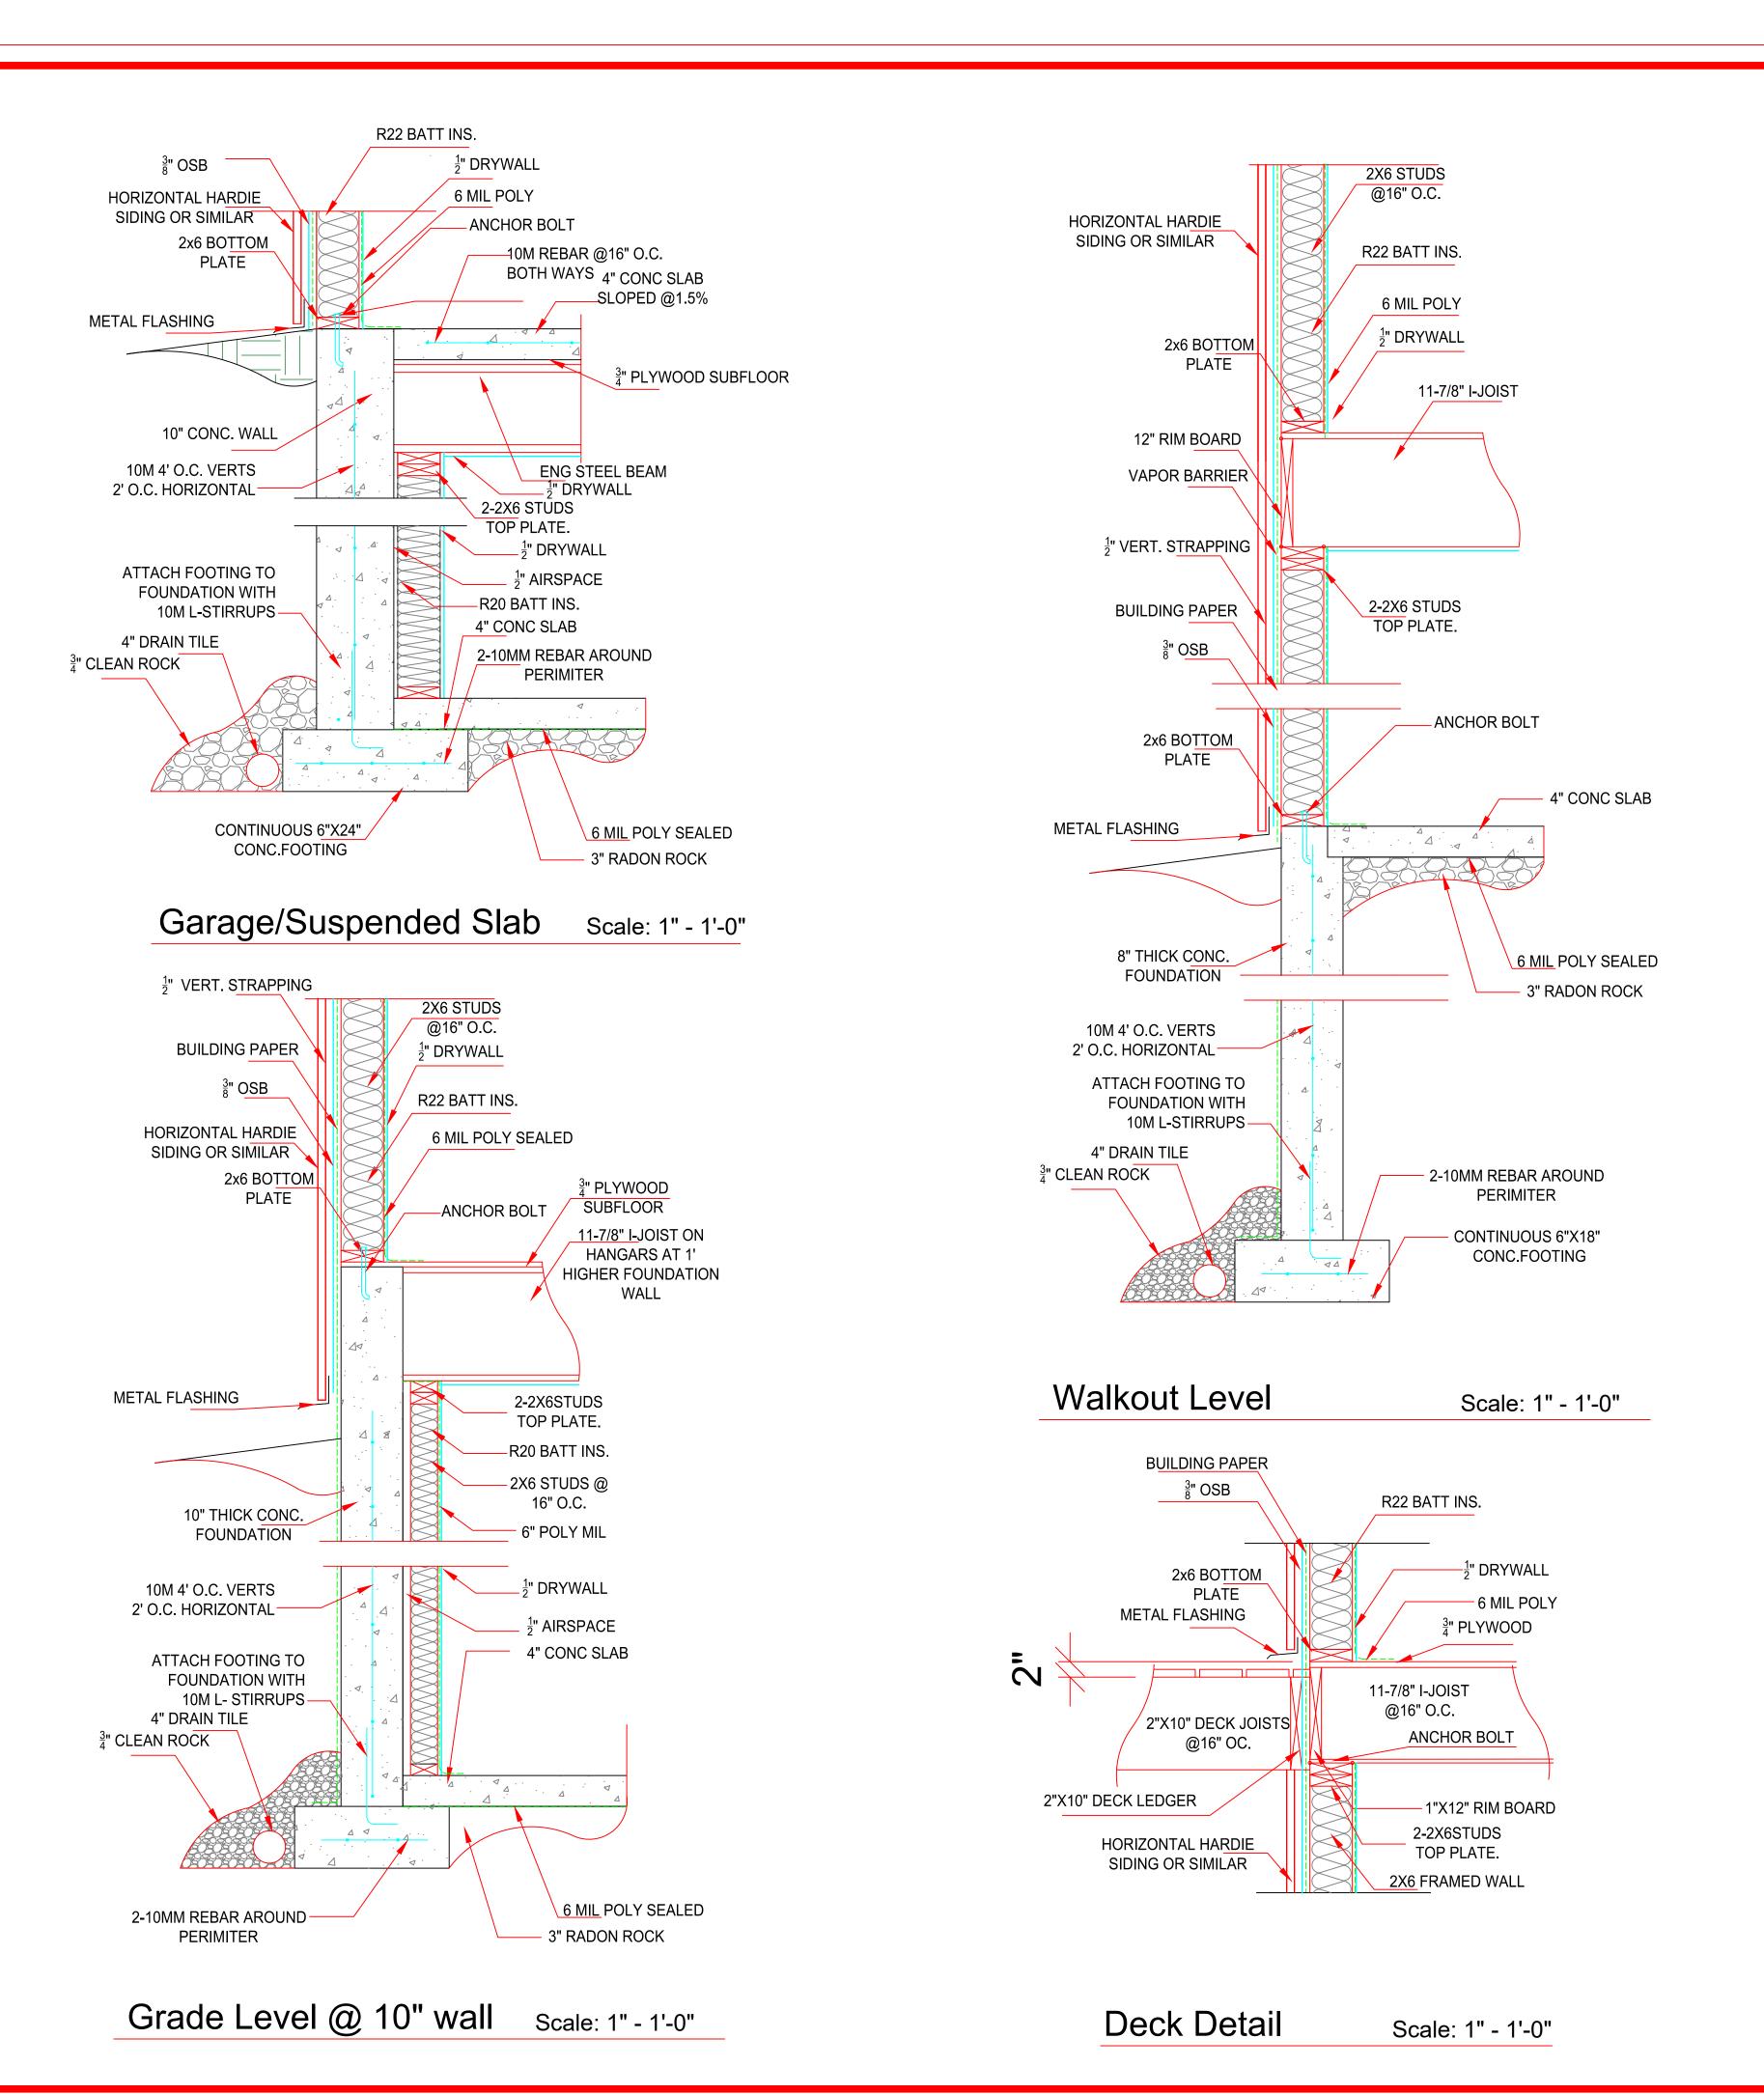

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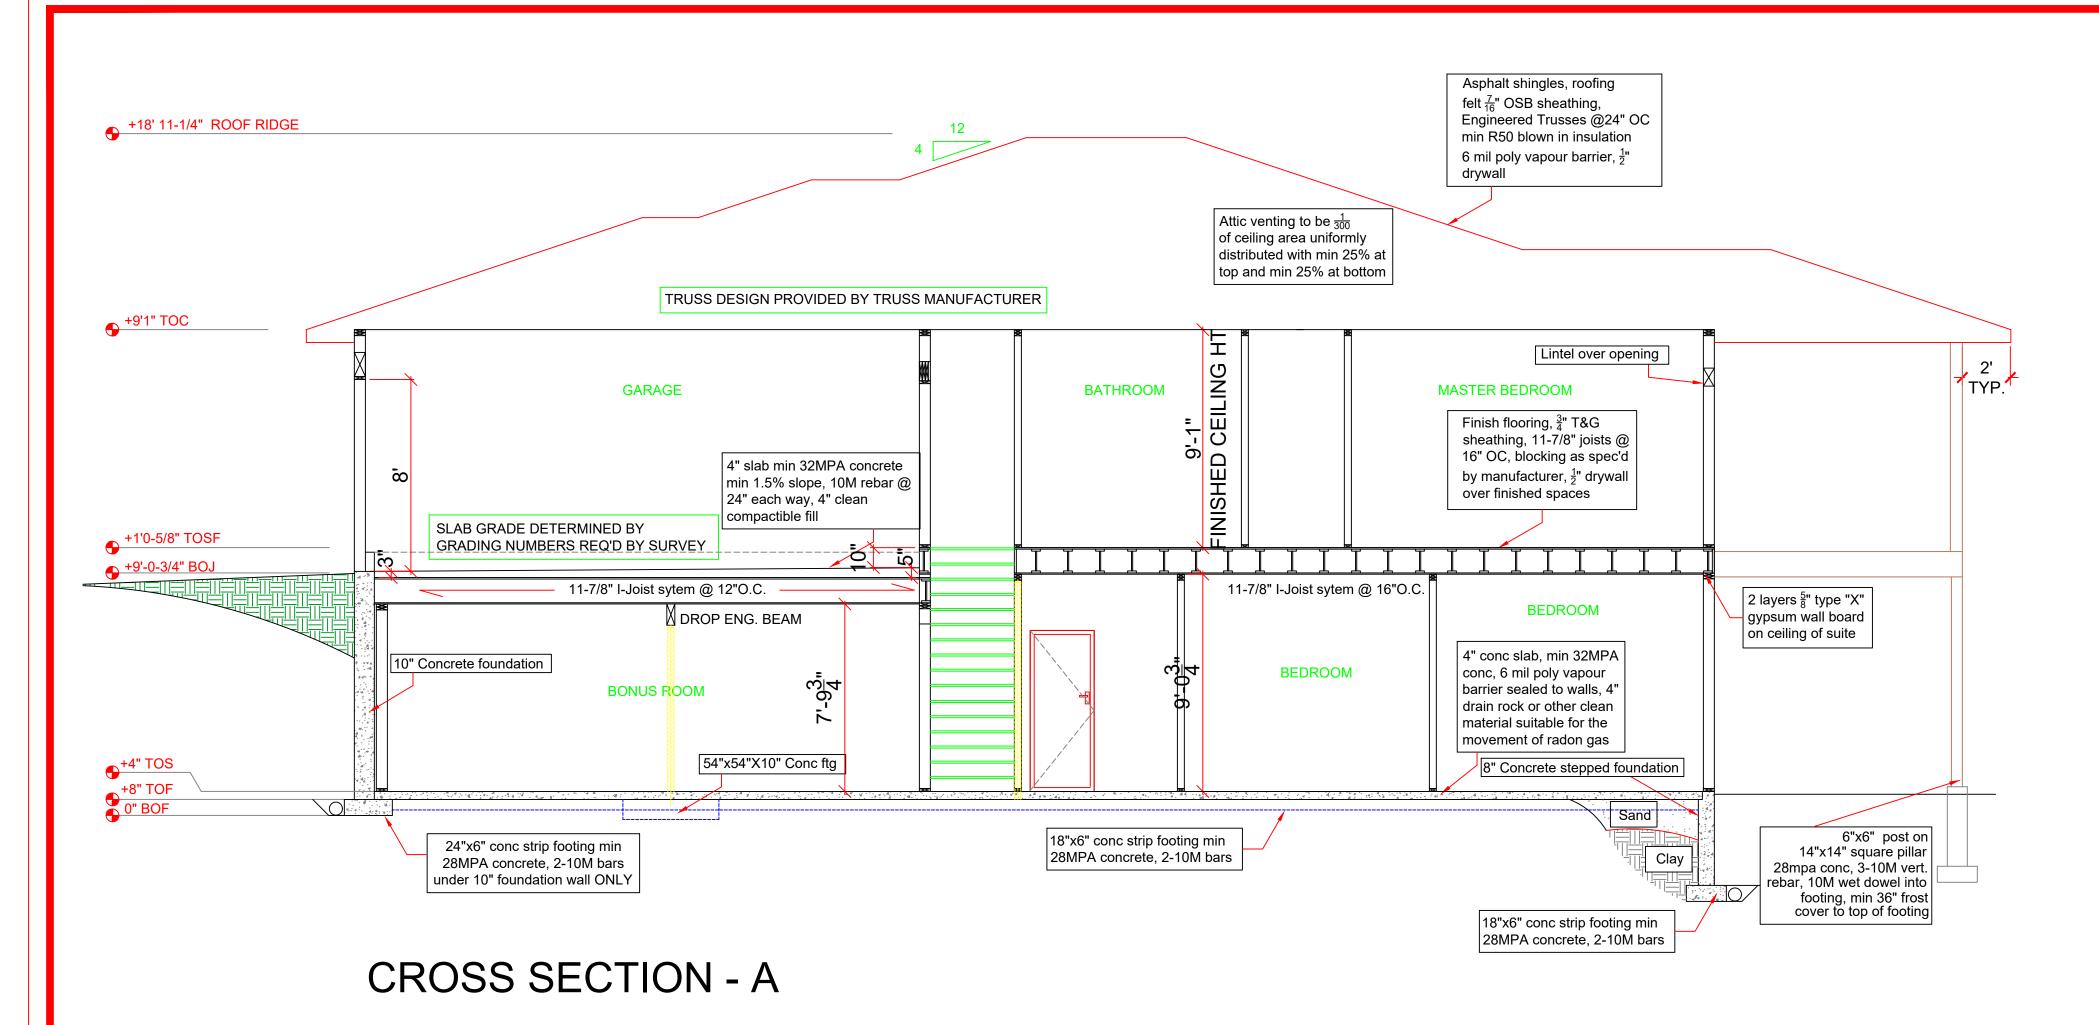
ROOF PLAN/ DETAILS

DATE
JUNE 26/2020

SCALE
VARIES

DRAWN
PC

CHECKED
XX



	<u> </u>	ı	WINDOW	2CHEDUL	E	
	MARK		SASH OPERATION	RO WIDTH	RO HEIGHT	COMMENTS
W	1	3070	PICTURE	3′0″	7′0″	
<b>/</b>	2	6050	SLIDER	6′0″	5′0″	
<b>/</b>	3	3060	SINGLE HUNG	3′0″	6′0″	
<b>/</b>	4	3060	SINGLE HUNG	3′0″	6′0″	
<b>/</b>	5	6060	PICTURE	6′0″	6′0″	
W	6	4060	PICTURE	6′0″	6′0″	
<b>V</b>	7	5046	SLIDER	5′0″	4′6″	
<u>/</u>	9	3060	SINGLE HUNG	3′0″	6′0″	
<del>√</del>	10	3050	SINGLE HUNG	3′0″	5′0″	
<del>/</del>	11	5040	SLIDER	5′0″	4′0″	
<b>√</b>	12	4040	SLIDER	4′0″	4′0″	
<b>/</b>	13	4040	SLIDER	4′0″	4′0″	
<b>√</b>	14	5040	SLIDER	5′0″	4′0″	
√	15	5040	SLIDER	5′0″	4′0″	
<b>√</b>	16	5040	SLIDER	5′0″	4′0″	
<b>V</b>	17	5040	SLIDER	5′0″	4′0″	

felt $\frac{7}{16}$ Engir	ralt shingles, roofing 5" OSB sheathing, neered Trusses @24" OC R50 blown in insulation poly vapour barrier, ½" all		Attic venting to be $\frac{1}{300}$ of ceiling area uniformly distributed with min 25% at top and min 25% at bottom	2' TYP.
	<b>B</b>			
	401.7"	11'-5"	DINING	
	12'-7" BEDROOM 2	Floor Opening	Finish flooring, $\frac{3}{4}$ " T&G sheathing, 11-7/8" joists @ 16" OC, blocking as spec'd by manufacturer, $\frac{1}{2}$ " drywall over finished spaces	-1- -1-
+1'0-5/8" TOSF +9'0-3/4" BOJ	11-7/8" I-Joist sytem @ 16"O.C.		11-7/8" I-Joist sytem @ 16"O.0	C
2x6 Perimiter wall  +4" TOS  +8" TOF  0" BOF  8" Concrete foundation	BATHROOM  4" conc slab, min 32MPA conc, 6 mil poly vapour barrier sealed to walls, 4" drain rock or other clean material suitable for the movement of radon gas  10'-2"  4"x4" Post on 6"x18" Conc ftg	Stair Note: 11-1/8" tread with 1" nosing. 8" run, rise as shown, <sup>3</sup> / <sub>4</sub> " plywood kicks. 1"OSB Treads. 2x12 stringers. All glued and screwed	2 layers \( \frac{5}{8} \)" type "X" gypsum wall board on ceiling and wall of suite  Load bearing wall/ privacy sound wall between suites  4"x4" Post on 6"x18" Conc ftg	PO-16 DARY SUITE

CROSS SECTION - B

DOOR SCHEDULE							
	MARK		DOOR OPERATION	RO WIDTH	RO HEIGHT	SIDE LITES	LOCATION
D	1	16080	OVERHEAD DOOR	16′	8′0″		GARAGE
D	2	3068	SWING SIMPLE	3'2-3/8"	8′0″		FRONT ENTRY
D	3	3068	SWING SIMPLE	3′2-3/8″	8′0″		REAR ENTRY
D	4	3068	SWING SIMPLE	3'2-3/8"	8′0″		M.B. DECK DOOR
 D	5	5068		5′0″			ENTRY CLOSET
D	6	2868	SWING SIMPLE	2′8″	6′11″		DEN
D	7	5068		5′0″			DEN CLOSET
D	8	3068	SWING SIMPLE	3′2-3/8″	6′11″		GARAGE MAN DOOR
D	9	2868	SWING SIMPLE	2′8″	6′11″		LAUNDRY
D	10	2868	SWING SIMPLE	2′8″	6′11″		BATHROOM
D	11	2868	SWING SIMPLE	2′8″	6′11″		BEDROOM
D	12	5060	SWING BI PART	5′0″	6′11″		BEDROOM CLOSE
D	13	2868	SWING SIMPLE	2′8″	6′11″		ENSUITE
D	14	2868	SWING SIMPLE	2′8″	6′11″		MASTER
D	15	2868	SWING SIMPLE	2′8″	6′11″		W.I.C.
D	16	3068	SWING SIMPLE	3'2-3/8"	8′0″		BASEMENT ENTRY
D	17	3068	SWING SIMPLE	3'2-3/8"	8′0″		BASEMENT ENTRY
D	18	3068	SWING SIMPLE	3′2-3/8″	8′0″		SUITE ENTRY
D	19	6068	SWING SIMPLE	6′0″	6′11″		STUDIO ROOM
D	20	2668	SWING SIMPLE	2′6″	6′11″		BASEMENT BATH
D	21	2868	SWING SIMPLE	2′8″	6′11″		MECH
D	22	3068	SWING SIMPLE	3′2-3/8″	6′11″		DOOR BELOW GARAGE
D	23	2868	SWING SIMPLE	2′8″	6′11″		SUITE BATH
D	24	2868	SWING SIMPLE	2′8″	6′11″		SUITE W.I.C.
D	25	2868	SWING SIMPLE	2′8″	6′11″		SUITE BEDROOM
D	26	2468	SWING SIMPLE	2′4″	6′11″		SUITE CLOSET

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	2	JUNE 26/20	WINDOW SIZE CHANGES
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REVISIONS

Wood Creek
Construction Ltd.

-Building with Confidence-

LEGAL DESCRIPTION

LOT 34, SEC 12, TP 20, R 10, W6M KDYD, Plan EPP69286 1181 - 17 AVE SE

JECT NO.

WINTERS

SECTIONS & WINDOW/DOOR SCHEDULES

DATE JUNE 26/2020	SHEET NUMBER
3/16"=1'	۸ ۸
PC	A-9
CHECKED	