

SHEET LEGEND
A1 - SITE PLAN & NOTES
A2 - ELEVATIONS
A3 - MAIN FLOOR PLAN
A4 - FOUNDATION PLAN
A5 - ROOF & DETAILS
A6 - SECTIONS & WINDOW/DOOR
SCHEDULES

GENERAL NOTES

- ALL CONSTRUCTION MATERIALS & WORKMANSHIP TO BE IN ACCORDANCE WITH THE CURRENT EDITION OF THE B.C. BUILDING CODE PLUMBING CODE, ELECTRICAL CODE, AND ALL OTHER CODES, ZONING, AND BYLAWS THAT MAY APPLY.
- 2. THE CONTRACTOR AND ALL SUB-TRADES ARE RESPONSIBLE FOR THE REVIEW OF ALL DRAWINGS AND SITE CONDITIONS PRIOR TO COMMENCING WORK OR ORDERING ANY MATERIAL, AND SHALL REPORT AND DISCREPANCIES THAT AFFECT DESIGN TO WOOD CREEK IMMEDIATELY
- 3. ALL FRAMING MATERIAL TO BE S.P.F. #2 OR BETTER WITH THE EXCEPTION OF WALL STUDS
- 4. CONCRETE FOOTINGS AND WALLS TO BE A MINIMUM 28MPA @28 DAYS. FLOOR SLABS AND SIDEWALKS TO BE MINIMUM 32MPA @ 28 DAYS.
- 5. ALL CONCRETE FOOTINGS TO BE PLACED ON ORIGINAL UNDISTURBED GROUND, FREE OF ALL ORGANIC, FROZEN OR FROSTY MATERIAL.
- 6. DAMP PROOF FOUNDATION WALLS BELOW GRADE WITH 2 COATS OF BITUMINOUS MATERIAL.
- 7. 6 MIL. ULTRAVIOLET RESISTANT POLY VAPOUR BARRIER ON A.) 4" OF GRANULAR COMPACTABLE FILL UNDER EXTERIOR OR GARAGE SLABS. OR B.) 4" OF $\frac{3}{4}$ " DRAIN ROCK OR OTHER MATERIAL SUITABLE FOR MOVEMENT OF RADON GAS UNDER INTERIOR SLABS.
- 8. ALL FOUNDATION DRAINS TO BE 4" PERFORATED P.V.C. WITH FILTER CLOTH AND MINIMUM 6" DRAIN ROCK, DRAINED TO MUNICPAL SERVICES ACCORDING TO LOCAL STANDARDS.
- 9. GRADE TO BE SLOPED AWAY FROM BUILDING AT ALL LOCATIONS ADJACENT TO BUILDING.
- 10. ALL TRUSSES I-JOISTS, BEAMS OR OTHER STRUCTURAL MEMBERS NOT COVERED IN B.C. BUILDING CODE TO BE DESIGNED AND ENGINEERED BY TRUSS MANUFACTURER OR STRUCTURAL ENGINEER PRIOR TO ANY FABRICATION.
- 11. CONTRACTOR TO VERIFY ALL PROPERTY AND FOUNDATION LINES WITH A LEGAL LAND SURVEYOR PRIOR TO PLACING FOOTINGS OR RUNNING SERVICES WITHIN BUILDING ENVELOPE.
- 12. ALL ROOF SPACES TO BE VENTILATED WITH SOFFIT AND ROOF VENTS WITH A MINIMUM DISTRIBUTION AREA OF 1/300. A MINIMUM OF 25% OF VENTS TO BE LOCATED AT ROOF. MINIMUM 25% TO BE LOCATED AT SOFFIT.
- 13. DOOR FRAMES AT ENTRANCES AND EXTERIOR SPACES TO DWELLING UNITS SHALL BE SOLIDLY BLOCKED BETWEEN DOOR FRAME AND STUDS AT THE HEIGHT OF THE DEADBOLT TO RESIST SPREADING.
- 14. ALL GLASS IN DOORS, SIDELITES OR WINDOWS WITHIN 12" OF FINISHED FLOOR TO BE CONSTRUCTED OF SAFETY GLASS.
- 15. RAIN WATER LEADERS NOT SHOWN ON PLAN . CONTRACTOR TO DETERMINE EXACT LOCATION SUITABLE TO SITE AND MUNICIPAL DRAINAGE.
- 16. ELECTRICAL LOCATIONS TO BE DETERMINED BY ELECTRICAL CONTRACTOR WITH THE APPROVAL OF THE HOME OWNER OR GENERAL CONTRACTOR AND IN ACCORDANCE WITH CURRENT ELECTRICAL CODE.
- 17. APPROVED SMOKE ALARMS TO BE INSTALLED WITH LOCATION APPROVED BY APPROPRIATE LOCAL MUNICIPALITY.
- 18. REFER TO LAOUTS AND SPECIFICATIONS FROM STRUCTURAL ENGINEER, FLOOR JOIST SUPPLIER, AND ROOF TRUSS MANUFACTURER FOR BEAM, POST, FOOTING LOCATIONS AND SIZES. ENSURE PROPER BEARING IS PROVIDED FOR ALL POINT LOADS. ANY STRUCTURAL SPECIFICATIONS SHOWN ON WOOD CREEK PLANS ARE ESTIMATES ONLY AND MAY NOT ACCURATELY REPRESENT LOADING AND SIZING, OR MAY NOT INCLUDE POINT LOADS OR STRUCTURAL MEMBERS DESIGNED BY OTHERS.

CONFORM TO ALL APPLICABLE LOCA
CODES AND BYLAWS. DESIGN OF
FOUNDATION AND FOOTINGS TO BE
MODIFIED TO SUIT LOCAL SOIL
CONDITIONS AS REQUIRED
DO NOT SCALE DRAWINGS. WRITTEI
DIMENSIONS SHALL TAKE PRECEDEN

BE USED ONLY FOR THE PURPOSE FOR

1	JULY 10/20	CLIENT CHANGES	
2	MAY 18/21	SITE PLAN	
3	JUNE 9/21	ROOF PITCH	
NO.	DATE	DESCRIPTION	
REVISIONS			



CIVIL ADDRESS


688 GRANDVIEW BENCH ROAD


ROJECT NO.

CUSTOMER STEVENS

SITE PLAN & GENERAL NOTES

date JUNE 9/21	SHEET NUMBER
SCALE NTS	Λ
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WINDOW/DOOR LEGEND FLOOR NOTES

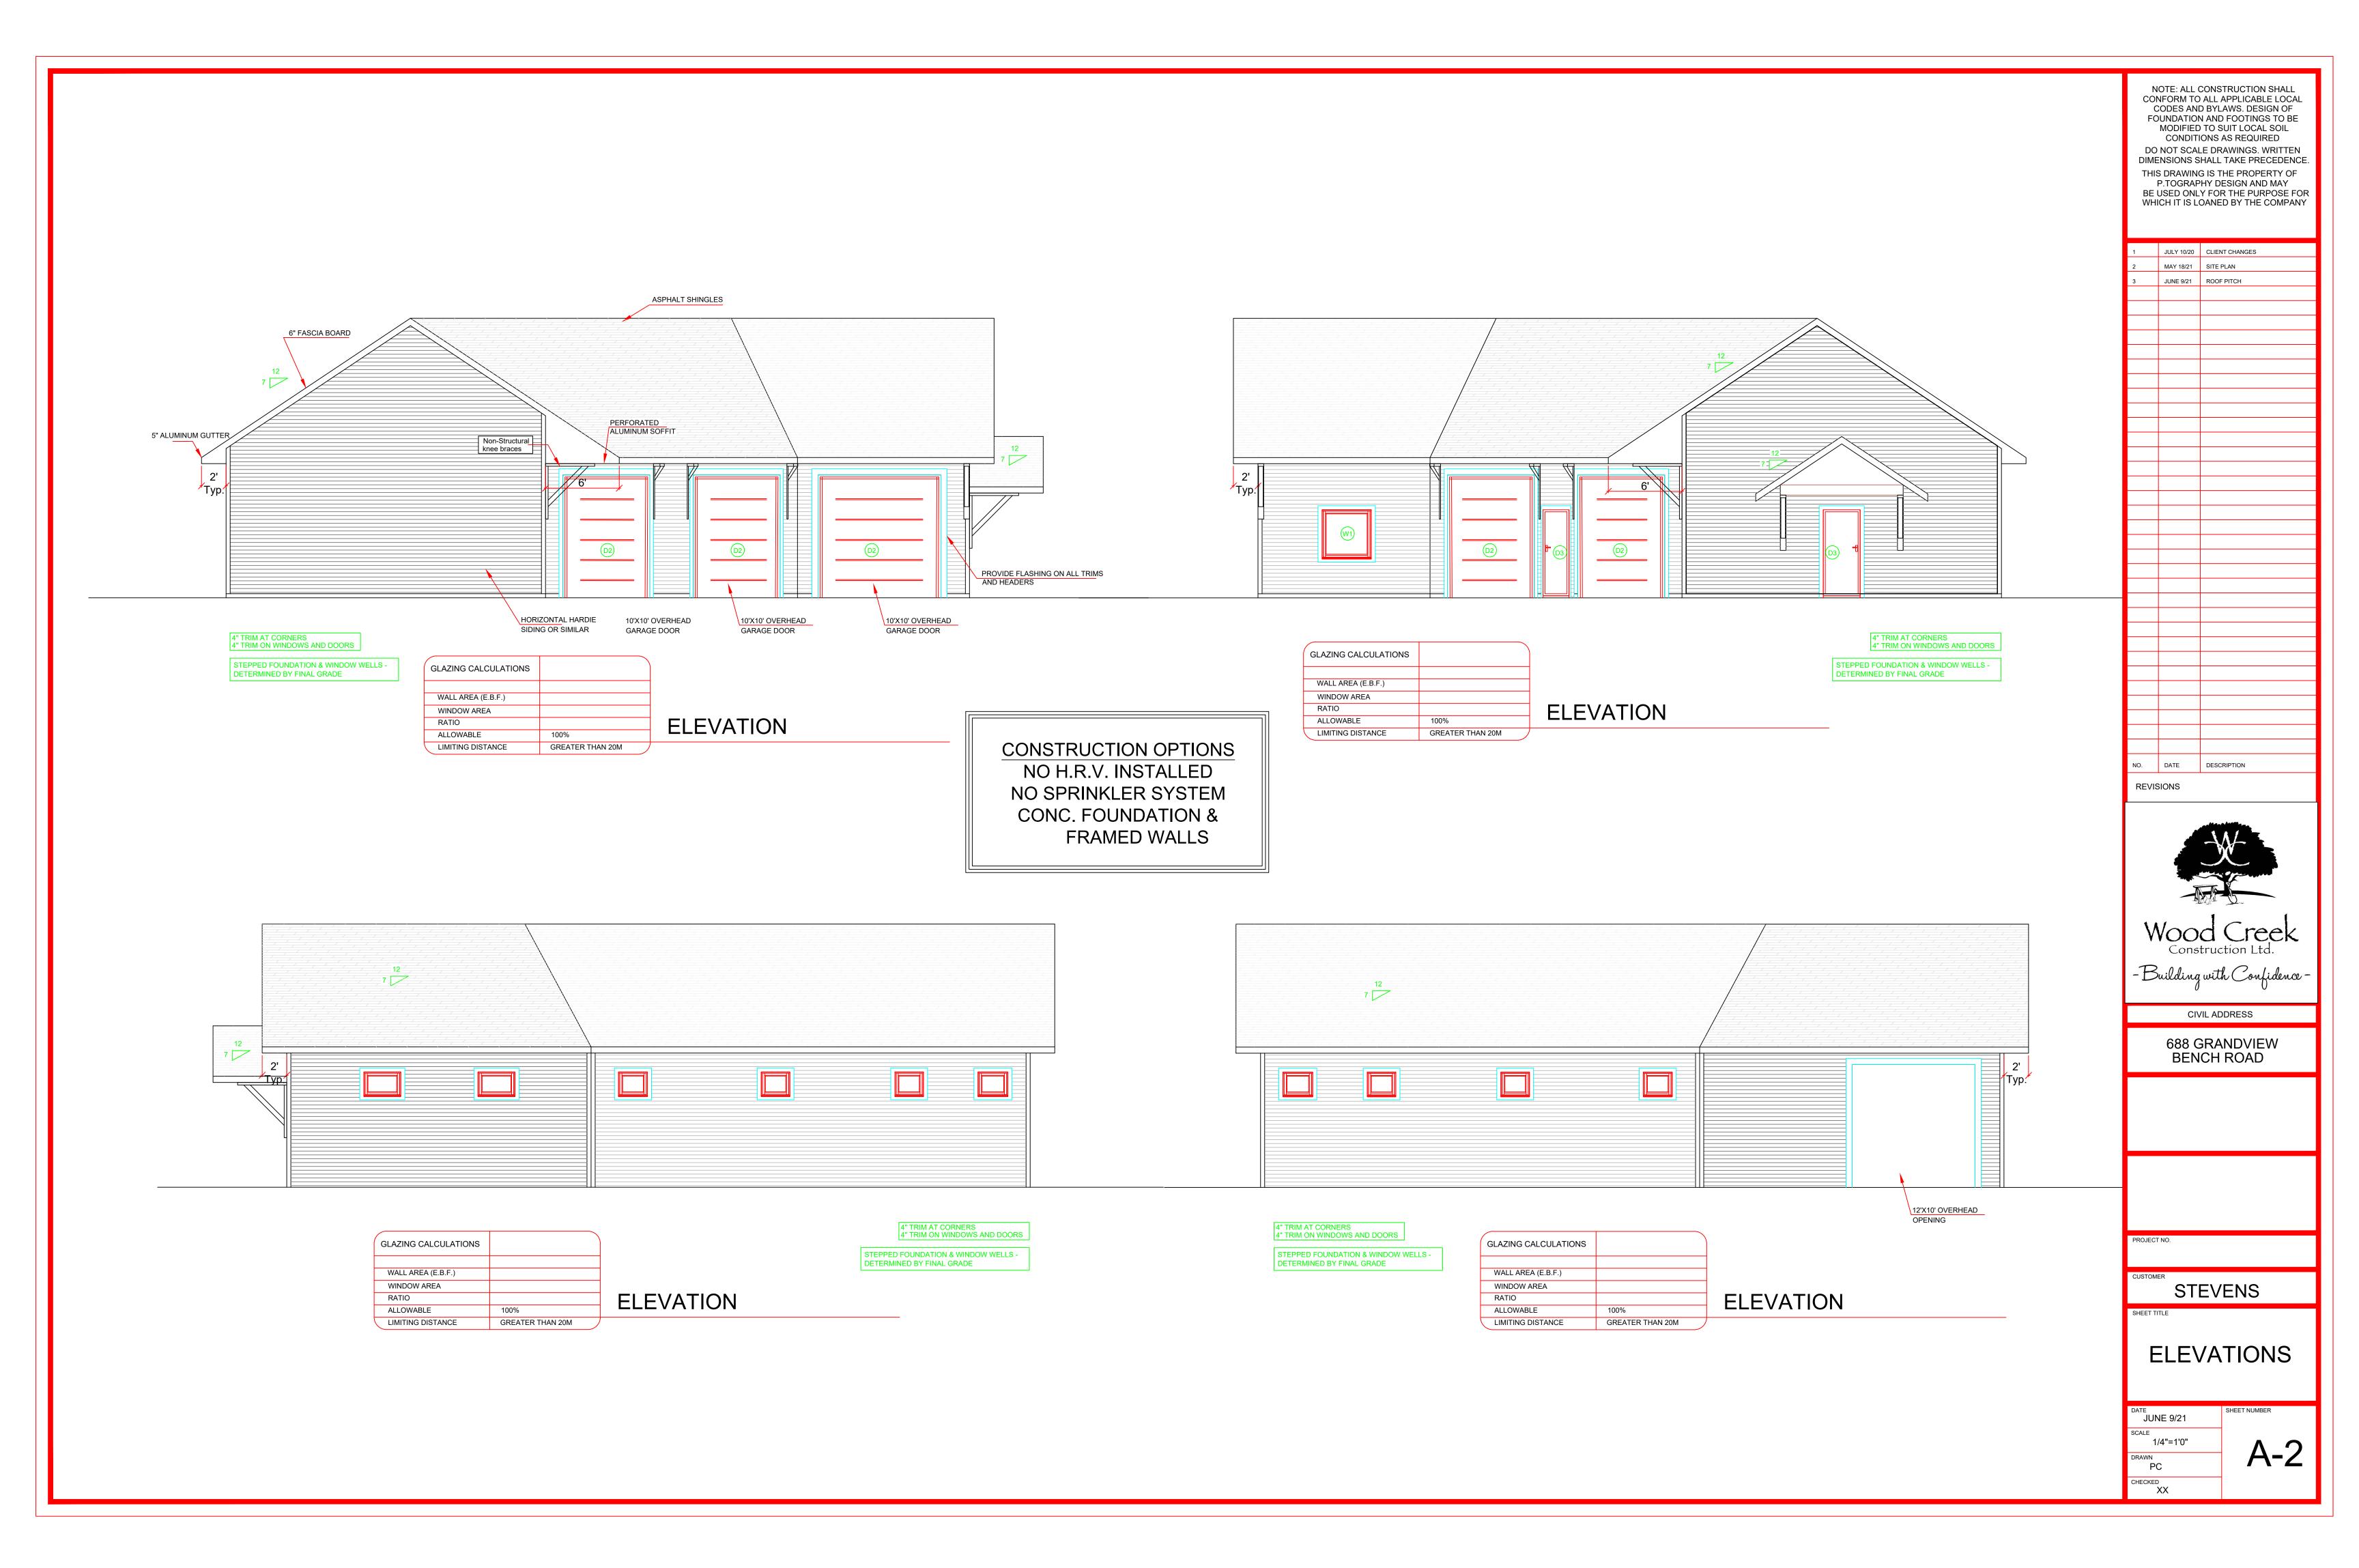- 1. FRAMED EXTERIOR WALLS
- INCLUDE EXTERIOR
 SHEATHING.
- 2. ALL DIMENSIONS SHOWN
 ARE TO FRAMING AND DO
 NOT INCLUDE DRYWALL
 OR OTHER FINISHES
- 3.ALL HEADERS TO BE
 3-2X10 IN 2X6 WALLS AND
 2-2X10 IN 2X4 WALLS
 UNLESS NOTED
 OTHERWISE
- 4. ALL DOORS AND WINDOWS FRAMED 4-1/2" FROM ADJACENT WALLS UNLESS NOTED OTHERWISE
- 5. ALL DOOR SLABS TRO
 MEASURE 80" IN HEIGHT
 UNLESS OTHERWISE
 NOTED
- 6. INDIVIDUAL ROOM AREAS
 ARE CALCULATED FROM
 INSIDE OF FRAMING
 WHEREAS THE OVERALL
 FLOOR AREA IS
 CALCULATED TO OUTSIDE
 EXTERIOR WALLS
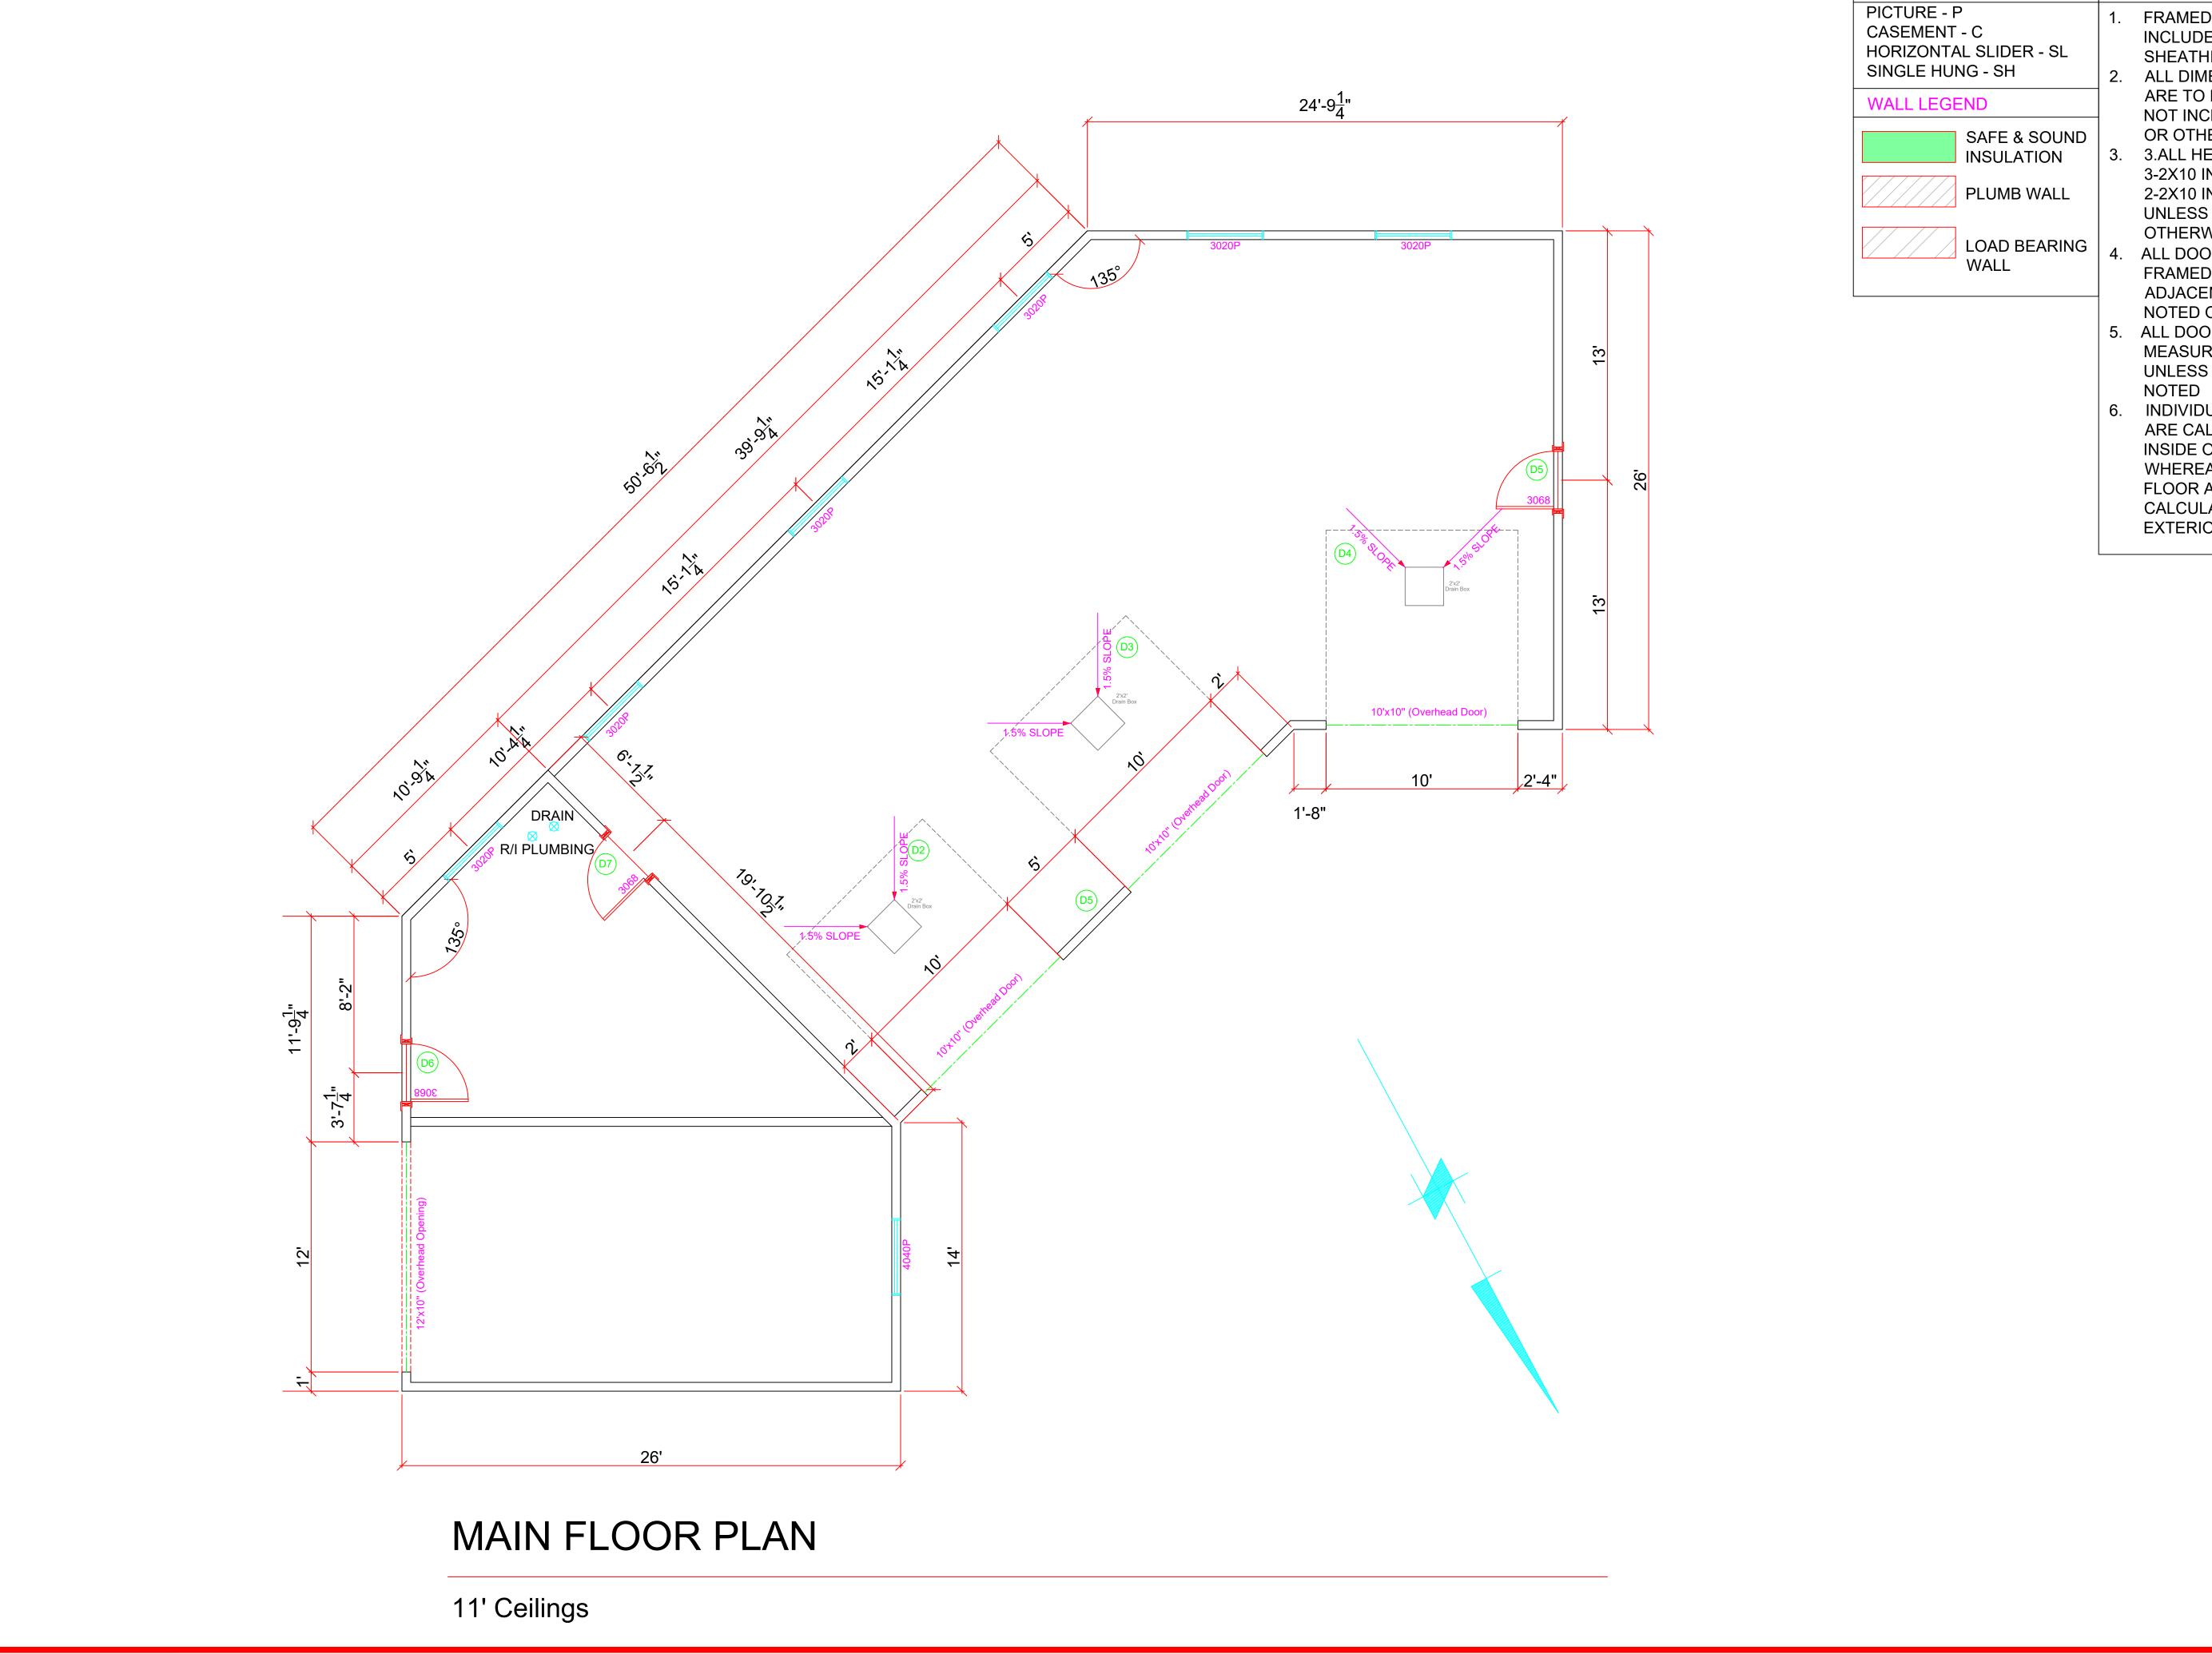
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MAY 18/21 SITE PLAN

	JUNE 9/21	ROOF PITCH
	DATE	DESCRIPTION
VIS	SIONS	



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688 GRANDVIEW BENCH ROAD

ROJECT NO.

STEVENS


GARAGE LAYOUT PLAN

JUNE 9/21

SCALE
3/8"=1'-0"

DRAWN
PC


A-3

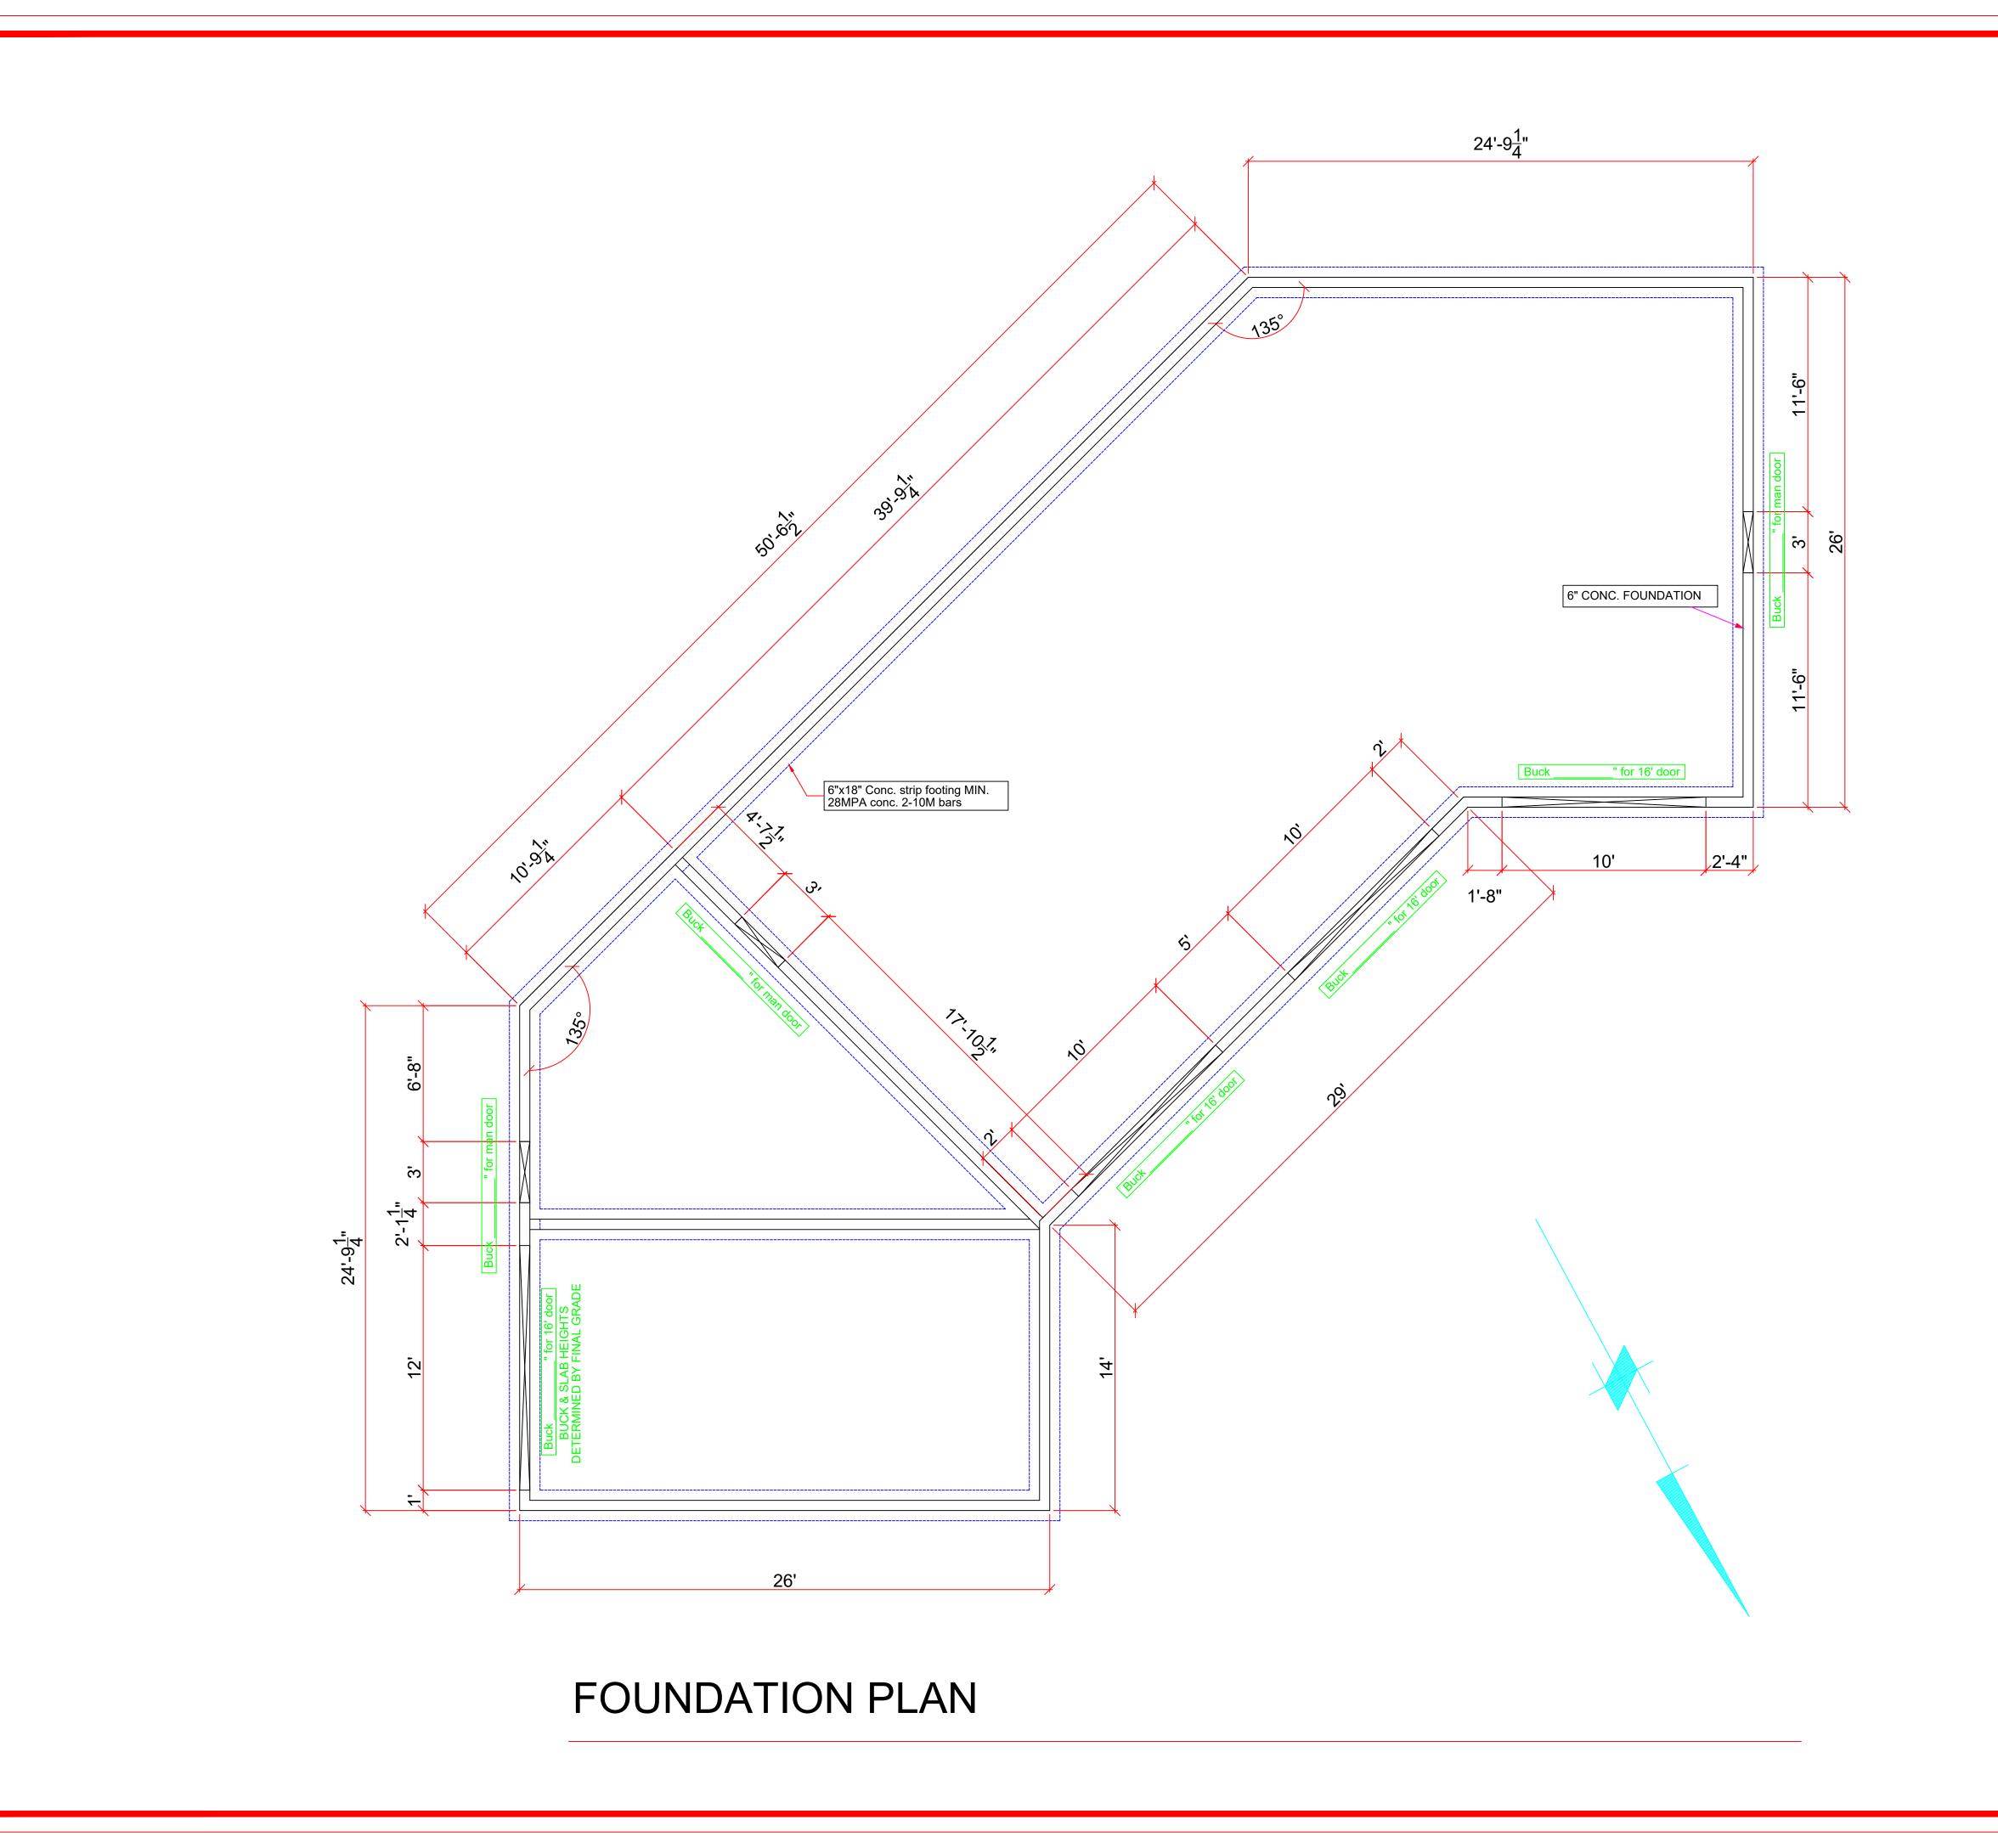

WINDOW/DOOR LEGEND

PICTURE - P CASEMENT - C HORIZONTAL SLIDER - SL SINGLE HUNG - SH

WALL LEGEND

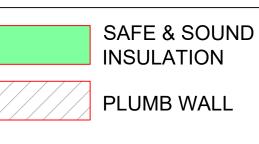

LOAD BEARING WALL

1' HIGHER FOUNDATION

LOOR NOTES

- FRAMED EXTERIOR WALLS DO NOT INCLUDE EXTERIOR SHEATHING.
- 2. ALL DIMENSIONS SHOWN ARE TO FRAMING AND DO NOT INCLUDE DRYWALL OR OTHER FINISHES
- 3.ALL HEADERS TO BE 3-2X10 IN 2X6 WALLS AND 2-2X10 IN 2X4 WALLS **UNLESS NOTED** OTHERWISE
- ALL DOORS AND WINDOWS FRAMED 4-1/2" FROM ADJACENT WALLS UNLESS NOTED OTHERWISE
- 5. ALL DOOR SLABS TRO MEASURE 80" IN HEIGHT **UNLESS OTHERWISE** NOTED
- 6. INDIVIDUAL ROOM AREAS ARE CALCULATED FROM INSIDE OF FRAMING WHEREAS THE OVERALL FLOOR AREA IS CALCULATED TO OUTSIDE EXTERIOR WALLS

NOTE: ALL CONSTRUCTION SHALL CONFORM TO ALL APPLICABLE LOCAL CODES AND BYLAWS. DESIGN OF FOUNDATION AND FOOTINGS TO BE MODIFIED TO SUIT LOCAL SOIL CONDITIONS AS REQUIRED

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JULY 10/20 CLIENT CHANGES

MAY 18/21 SITE PLAN

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3	JUNE 9/21	ROOF PITCH		
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688 GRANDVIEW BENCH ROAD

SLAB NOTE

BACKFILL NOTE:

BACKFILL HEIGHT

CANNOT EXCEED REQ-

UIREMENTS AS PER

SUBSECTION 9.15.4

OF BC BLDG CODE

5" conc slab, min 32MPA conc, 4" drain rock or other clean material suitable for the movement of radon gas

FOOTING NOTE


6"x18" conc strip footing min 28MPA concrete, 2-10M bars around 8" foundation wall


STEVENS


FOUNDATION **PLAN**


DATE JUNE 9/21 SCALE 1/4"=1'-0"

A-4

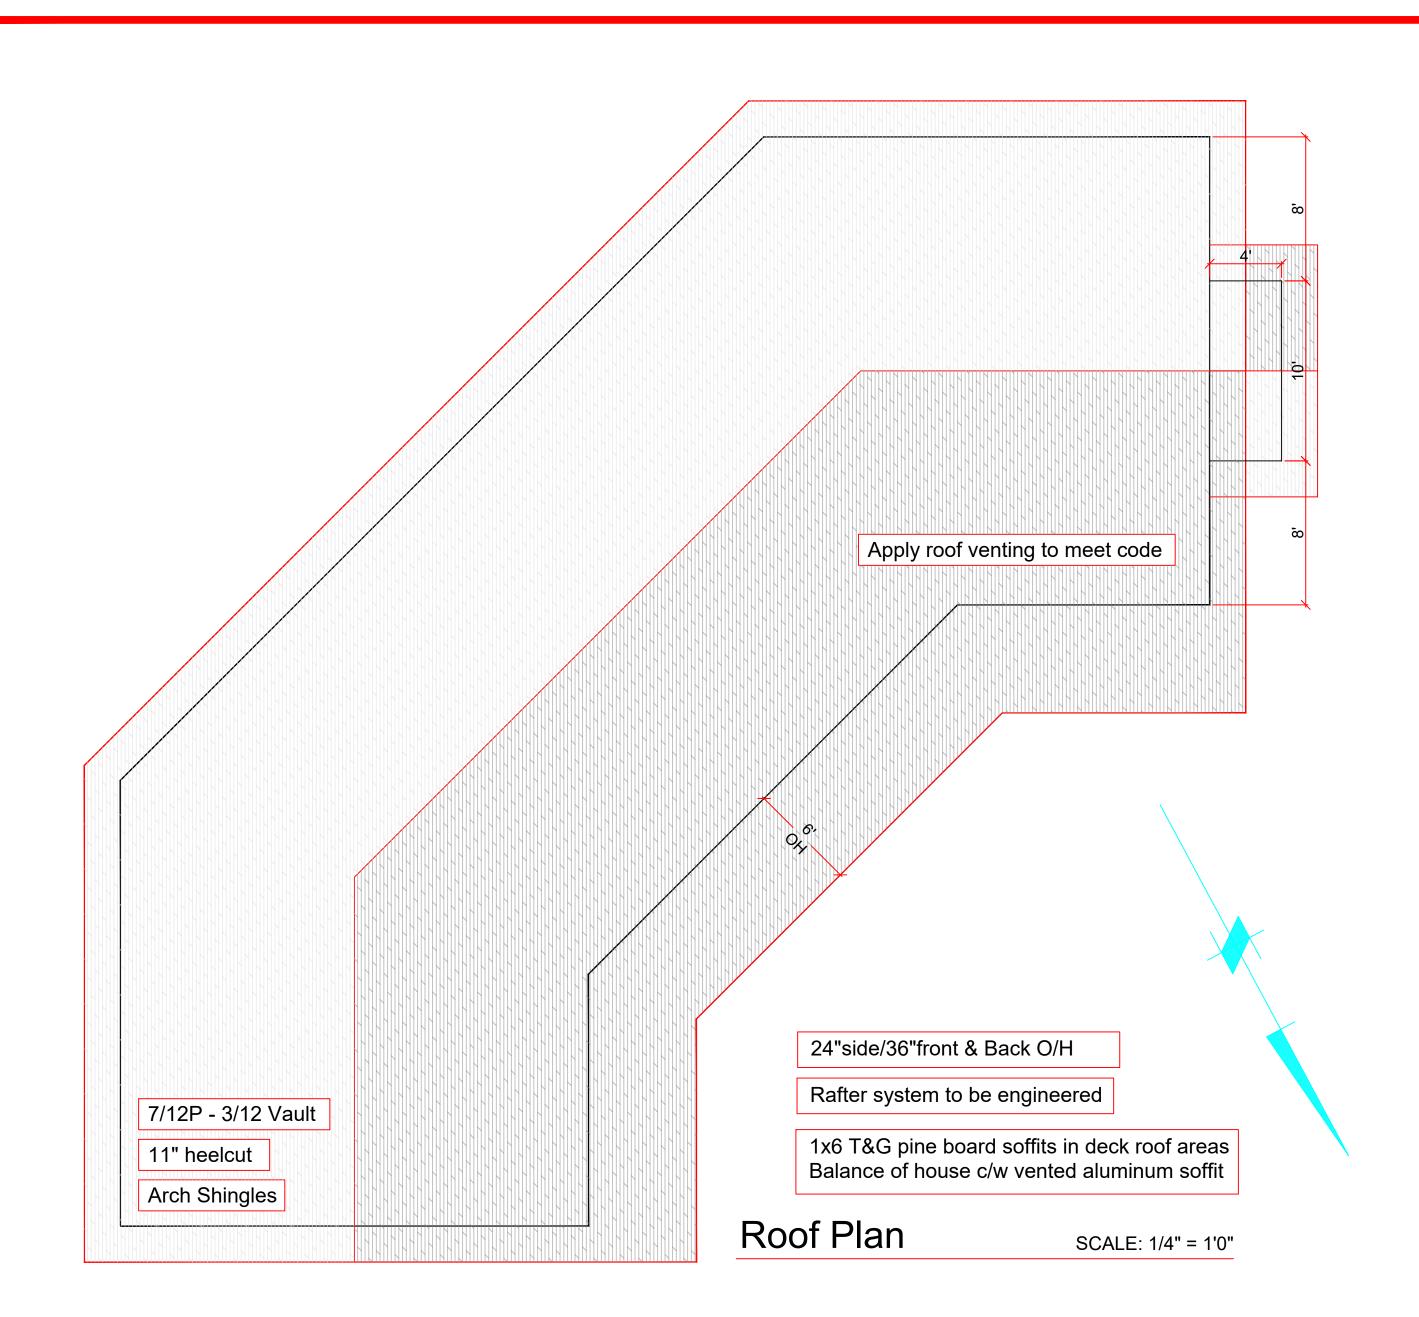

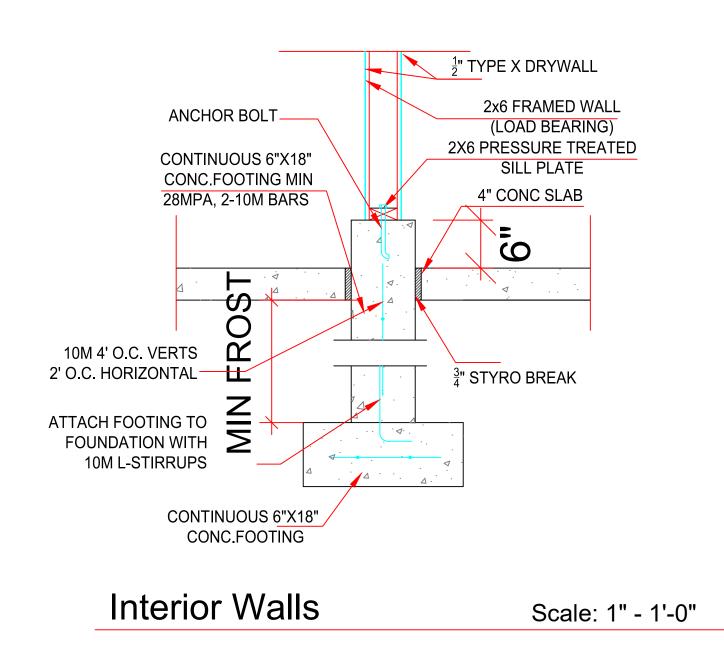

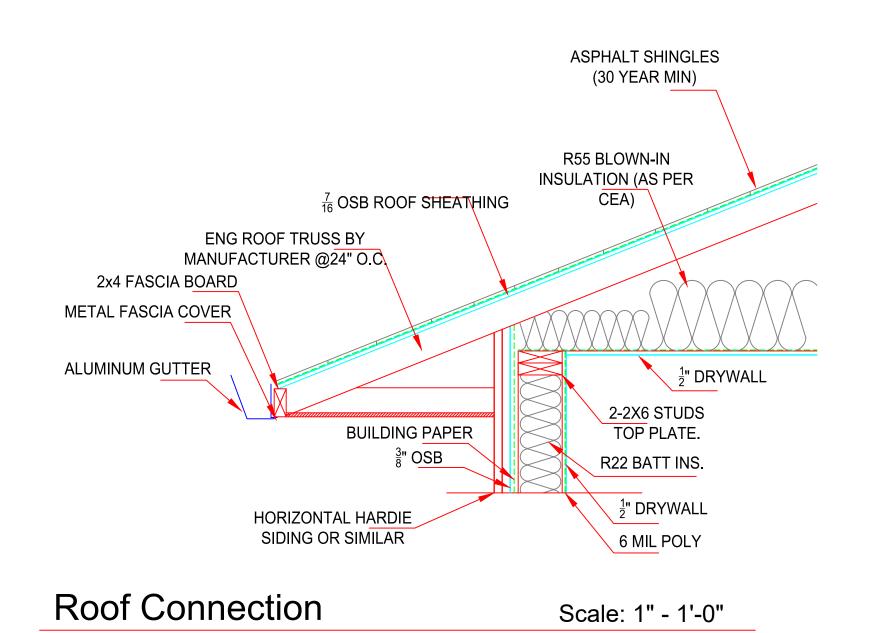

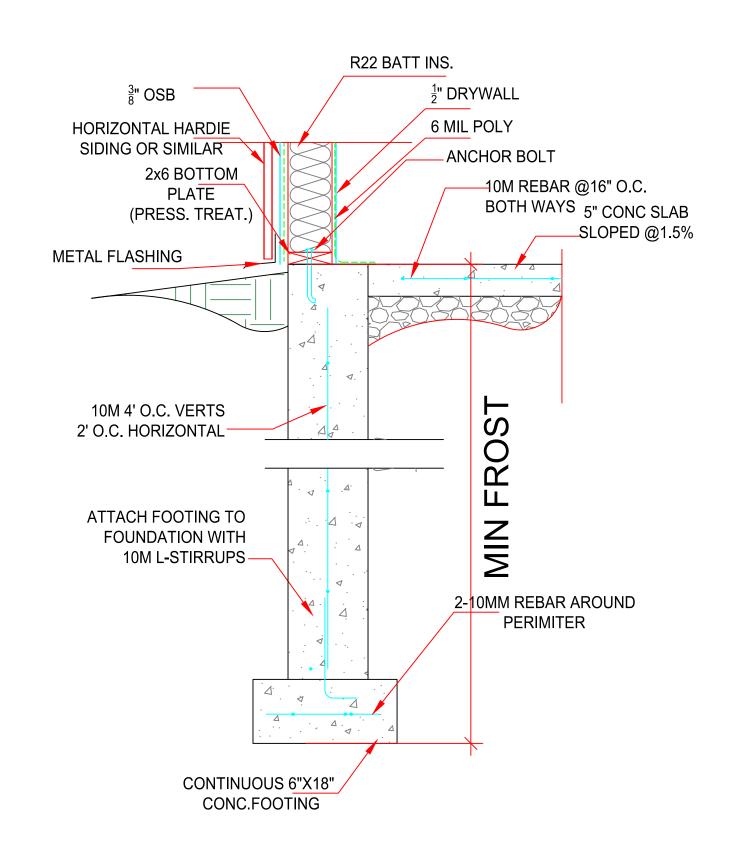

Garage Slab

Scale: 1" - 1'-0"

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DJECT NO.

STEVENS

ROOF PLAN/ DETAILS


JUNE 9/21

SCALE
VARIES

DRAWN
PC

THECKED
XX

	WINDOW SCHEDULE					
N	ИARK		SASH OPERATION	RO WIDTH [+1/8"]	RO HEIGHT [+1/8"]	COMMENTS
W	1	3020	PICTURE	3′0″	2′0″	
W	2	3020	PICTURE	3′0″	2′0″	
W	3	3020	PICTURE	3′0″	2′0″	
W	4	3020	PICTURE	3′0″	2′0″	
W	5	3020	PICTURE	3′0″	2′0″	
W	6	3020	PICTURE	3′0″	2′0″	
W	7	4040	PICTURE	4′0″	4′0″	

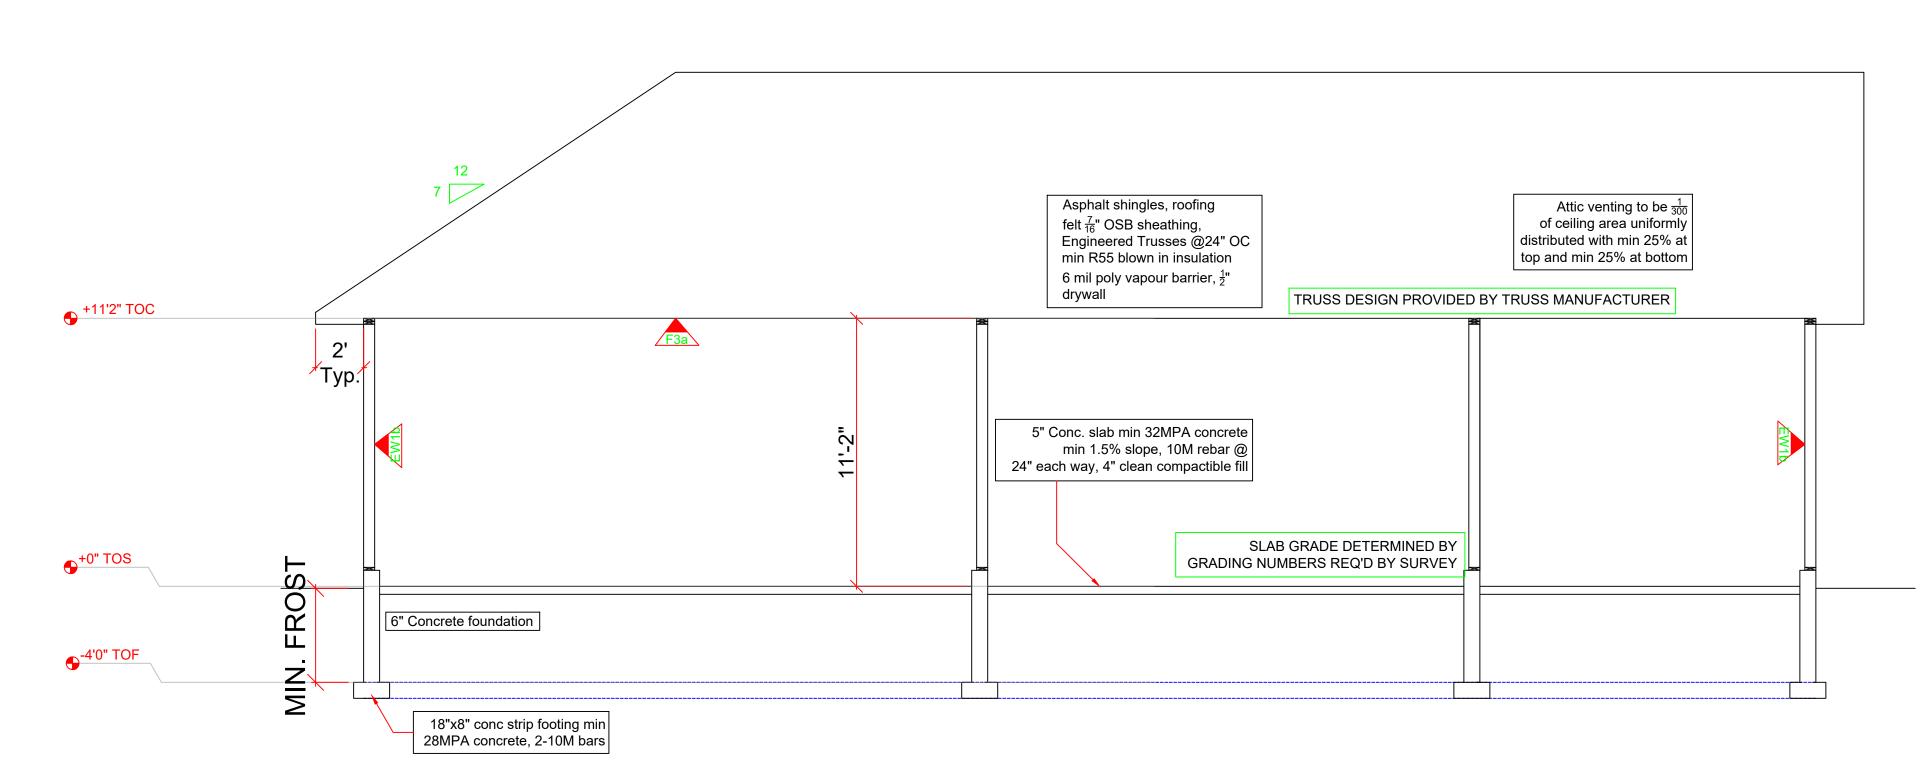

SECTION

	DOOR SCHEDULE						
	MARK		DOOR OPERATION	RO WIDTH	RO HEIGHT	SIDE LITES	LOCATION
D	2	100100	OVERHEAD DOOR	10′	10′0″		GARAGE DOOR
D	3	100100	OVERHEAD DOOR	10′	10′0″		GARAGE DOOR
D	4	100100	OVERHEAD DOOR	10′	10′0″		GARAGE DOOR
D	5	3068	SWING SIMPLE	3'2-3/8"	6′11″		EXT. MAN DOOR
D	6	3068	SWING SIMPLE	3'2-3/8"	6′11″		EXT. MAN DOOR
D	7	3068	SWING SIMPLE	3′2-3/8″	6′11″		INT, MAN DOOR

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CIVIL ADDRESS

688 GRANDVIEW BENCH ROAD

OJECT NO.

CUSTOMER STEVENS

SECTIONS & WINDOW/DOOR SCHEDULES

DATE
JUNE 9/21

SCALE
3/16"=1'

DRAWN
PC

CHECKED

A-6