

MAX BUILDING HEIGHT: 9.83m  
MAX ALLOWABLE BUILDING HEIGHT: 10m  
SEE AT FOR VISUALIZATION

REVISED 07/27/21  
MONTH DAY YEAR

NO.	REFERENCE DRAWINGS

**NOTE TO GENERAL CONTRACTOR**  
QUESTIONS REGARDING THE DESIGN ARE WELCOME.  
PLEASE FEEL FREE TO DIRECT ANY QUESTIONS  
REGARDING THE DESIGN TO OUR OFFICE AT  
828-0321. PROJECT MANAGER AND  
DESIGNER IS IVORY WINSTON

NO.	REVISION	DATE	BY
5	UPDATED PERMIT ISSUE	16JUL21	I.W.
4	ISSUED FOR PERMIT	08JUN21	I.W.
3	ISSUED FOR PRICING	01MAR21	I.W.



#101-1402 McGill Road, Kamloops, BC  
V2C 1L3; 250-828-0321

<b>A0</b>	PROJECT	ADKINS CUSTOM
	APPROVED	I.W.
	SCALE	AS NOTED
	DATE	JAN 2021

CLIENT  
ADKINS, MIKE

TITLE  
PERSPECTIVE VIEWS

JOB NUMBER	40K05	AO OF 12	5
		DWG NO.	REV

CANCEL ALL PRINTS BEARING EARLIER REVISION



GENERAL NOTES

- ITEMS LISTED OR NOTED WITHIN THESE NOTES ARE FOR GUIDANCE ONLY AND DO NOT NECESSARILY CONSTITUTE THE ENTIRE EXTENT OF WORK REQUIRED TO BE CARRIED OUT.
- BEFORE BIDDING THIS PROJECT THE CONTRACTOR SHALL ENSURE THAT THEY HAVE A FULL UNDERSTANDING OF THE STANDARD CONSTRUCTION PRACTICES AND WORK OUTLINED IN THESE DRAWINGS.
- IT IS HEREBY UNDERSTOOD THAT ALL LOCAL CODES AND REGULATIONS, THE MOST RECENT EDITION OF THE B.C. BUILDING CODE, AND ALL REVISIONS, SHALL APPLY IN THEIR ENTIRETY AS THE MINIMUM STANDARD TO ALL SECTIONS OF THE WORK.
- ANY CHANGES TO OR DEVIATIONS FROM THESE PLANS IS THE FULL RESPONSIBILITY OF THE CONTRACTOR AND MUST BE APPROVED IN WRITING BY THE OWNER AND REPORTED TO THIS OFFICE.
- ALL LABOUR SHALL BE PERFORMED IN THE BEST AND MOST WORKMANSHIP LIKE MANNER BY QUALIFIED TRADESPEOPLE.
- COMPLIANCE WITH THE B.C. HPO IS REQUIRED ON THIS PROJECT.
- A DISCLOSURE OF CURRENT N.C.B. STATUS WILL BE REQUIRED PRIOR TO AWARDING ANY PORTION OF THIS PROJECT.
- ALL CONTRACTORS SHALL CO-OPERATE WITH EACH OTHER AND CO-ORDINATE THEIR WORK FOR THE PROPER COMPLETION OF THE PROJECT.

ERRORS AND OMISSIONS

- PROCAD DESIGNS LIMITED MAKES EVERY EFFORT TO PROVIDE COMPLETE AND ACCURATE HOME PLANS. HOWEVER, NO LIABILITY IS ASSUMED FOR ANY ERRORS OR OMISSIONS AND IT IS THE RESPONSIBILITY OF THE BUILDER TO CHECK AND VERIFY ALL DIMENSIONS BEFORE COMMENCEMENT OF CONSTRUCTION.
- ANY DISCREPANCIES OR OMISSIONS SHOULD BE REPORTED TO THIS OFFICE FOR CLARIFICATION.

COPYRIGHT

- THESE PLANS AND DESIGNS THEREIN ARE COPYRIGHT AND THE EXCLUSIVE PROPERTY OF PROCAD DESIGNS LIMITED AND MAY NOT BE REPRODUCED IN PART OR WHOLE WITHOUT WRITTEN PERMISSION.
  - PROCAD DESIGNS LIMITED GRANTS THE PURCHASER THE RIGHT TO BUILD ONLY ONE STRUCTURE FROM THESE PLANS.
- BUILDING SITE**
- BUILDER SHALL LOCATE SEWER, WATER, GAS AND ELECTRICAL SERVICES.
  - WELLS, SEPTIC TANK AND DISPOSAL FIELD (IF REQUIRED) SHALL CONFORM TO LOCAL AND DISTRICT REGULATIONS.
  - INSTALL PROTECTIVE BARRIERS AROUND EXISTING TREES DURING CONSTRUCTION.
  - TEMPORARY AND FINISHED GRADE SHALL SLOPE AWAY FROM THE BUILDING.
  - THE SITE SHALL, AT ALL TIMES, BE KEPT CLEAN; DEBRIS SHALL BE NEATLY FILED AND REMOVED AS NEEDED.

FOUNDATION NOTES

- FOOTINGS AND FOUNDATIONS SHALL BE DROPPED TO SOLID UNDISTURBED NATIVE SOIL OR COMPACTED FILL AND TO BELOW FROST LINE.
- ALL CONCRETE SHALL HAVE A MINIMUM COMPRESSIVE STRENGTH OF 32 MPa AFTER 28 DAYS INCLUDING GARAGE SLABS, CARPORT SLABS AND EXTERIOR STEPS.
- BACK FILLING OF FOUNDATION WALLS SHALL NOT BE DONE UNTIL THE CONCRETE HAS REACHED ITS REQUIRED 28-DAY STRENGTH AND THE ENTIRE MAIN FLOOR JOISTS AND SHEATHING HAVE BEEN INSTALLED TO GIVE THE FOUNDATION PROPER SUPPORT.
- REINFORCING STEEL SHALL BE IN ACCORDANCE WITH ASTM A615 GRADE 400.
- REINFORCING SHALL HAVE MINIMUM CONCRETE COVER OF 3" WHEN LAID AGAINST GROUND. SPLICES SHALL BE 34 X BAR DIAMETER.
- FOUNDATION WALLS HIGHER THAN PERMITTED IN THE BUILDING CODE ARE REQUIRED TO BE DESIGNED BY AN ENGINEER.
- ANY ENGINEERED FOUNDATION DRAWINGS SUPERSEDE THOSE INCLUDED IN THESE PLANS.
- EXISTING GRADE SHOWN IS TO BE CONSIDERED APPROXIMATE AND FOUNDATION WALL HEIGHTS MAY NEED TO BE ADJUSTED DEPENDING ON ACTUAL SITE CONDITIONS.

PLAN & FRAMING NOTES

- ALL DIMENSIONS ARE TAKEN FROM OUTSIDE FACE OF EXTERIOR STUDS AND TO CENTER LINE OF INTERIOR STUD WALLS UNLESS NOTED OTHERWISE.
- FACE OF EXTERIOR STUD WALL AND FOUNDATION TO BE FLUSH.
- FRAMING LUMBER GRADES AND SPECIES SHALL CONFORM TO B.C. BUILDING CODE, RESIDENTIAL STANDARD.
- ALL WOOD IN CONTACT WITH CONCRETE TO BE DAMPPROOFED WITH SILL GASKET OR OTHER APPROVED METHOD.
- DOUBLE JOISTS UNDER NON LOAD BEARING WALLS RUNNING PARALLEL TO THE JOISTS.
- LINTELS SHALL BE 2-2X10 UNLESS OTHERWISE NOTED.
- ROOF TRUSSES SHALL BE PRE-ENGINEERED BY MANUFACTURER, AND A COPY SUPPLIED TO THIS OFFICE FOR REVIEW.
- IN ORDER TO ACCOMMODATE FINISHED FLOOR HEIGHTS, ADJUSTMENTS TO NOTED RISER HEIGHTS MAY BE REQUIRED. ALL RECALCULATIONS OF RISER HEIGHTS MUST CONFORM TO LOCAL BUILDING CODES AND MEET WITH OWNER'S AND/OR DESIGNER'S REQUIREMENTS.
- BUILDER IS RESPONSIBLE FOR SUPPLYING ADEQUATE HEATING TO ALL PARTS OF THE HOUSE.
- LOCATION OF UNDIMENSIONED FIXTURES, OUTLETS, DUCT WORK AND ITEMS SHOWN OR NOTED BUT NOT DIMENSIONED, SHALL BE CONSIDERED APPROXIMATE. THE ACTUAL LOCATIONS SHALL BE DIRECTED BY THE OWNER AND AS REQUIRED TO SUIT JOB CONDITIONS.


ELECTRICAL NOTES

- ALL ELECTRICAL WORK TO COMPLY WITH APPLICABLE CODES AND REGULATIONS.
- ELECTRICAL PLANS SHOWN ARE TO BE USED AS A GUIDE ONLY, AND ALL ITEMS TO BE CONFIRMED WITH OWNER.
- SEE ELECTRICAL PLANS FOR FURTHER NOTES.

INSULATION/SOUNDPROOFING NOTES


- PROVIDE MIN R50 BLOWN INSULATION AND 6 MIL VAPOUR BARRIER IN ALL ROOF CEILINGS. MINIMUM R20 INSULATION IN SLOPING CEILINGS UNLESS NOTED OTHERWISE.
- PROVIDE R8 INSULATION FOR SOUND SEPARATION WHERE REQUIRED OR AS SHOWN.
- PROVIDE MIN R24 AND 6 MIL POLY VAPOUR BARRIER IN ALL EXTERIOR WALLS.

SHEET LIST	
NUMBER	NAME
A0	PERSPECTIVE VIEWS
A1	SITE PLAN
A2	FOUNDATION PLAN
A3	GRAVELSPACE PLAN
A4	MAIN FLOOR PLAN
A5	UPPER FLOOR PLAN
A6	ROOF PLAN
A7	NORTH AND SOUTH ELEVATIONS
A8	EAST AND WEST ELEVATIONS
A9	SECTIONS
A10	SECTIONS & THERMAL CALCS
A11	ELECTRICAL PLANS
A12	ELECTRICAL PLANS

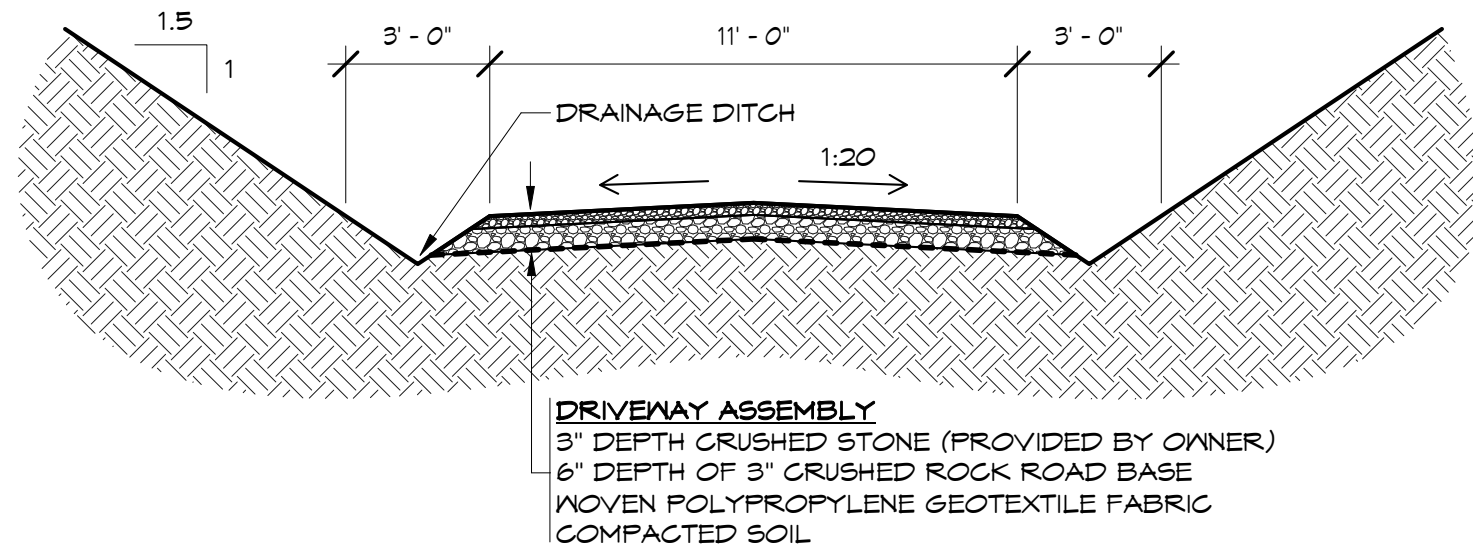


TYPICAL DRIVEWAY SECTION  
SCALE: 1/4" = 1'-0"

CIVIC ADDRESS: 3390 RONCASTLE ROAD BLIND BAY, B.C.	
LEGAL DESCRIPTION: L 6 SEC 30 TP 22 R 10 W OF THE 6TH MERIDIAN KAMLOOPS DIVISION YALE DISTRICT PL KAP 92908	
FID: 029-008-239	
ZONING: RR1	
LOT AREA: 108,900 ft² [10,117.1 m²]	MAX. COVERAGE: 0%
PROPOSED LOT COVERAGE:	
HOUSE .....1,931 ft² [180.0 m²]	
GARAGE.....1,042 ft² [96.8 m²]	
DECK / PATIO.....114 ft² [10.6 m²]	
TOTAL PROPOSED COVERAGE: 3,043 ft² [281.3 m²] 2.8%	

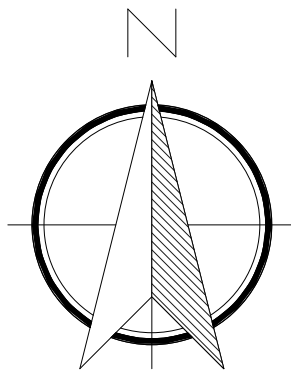

RONCASTLE ROAD

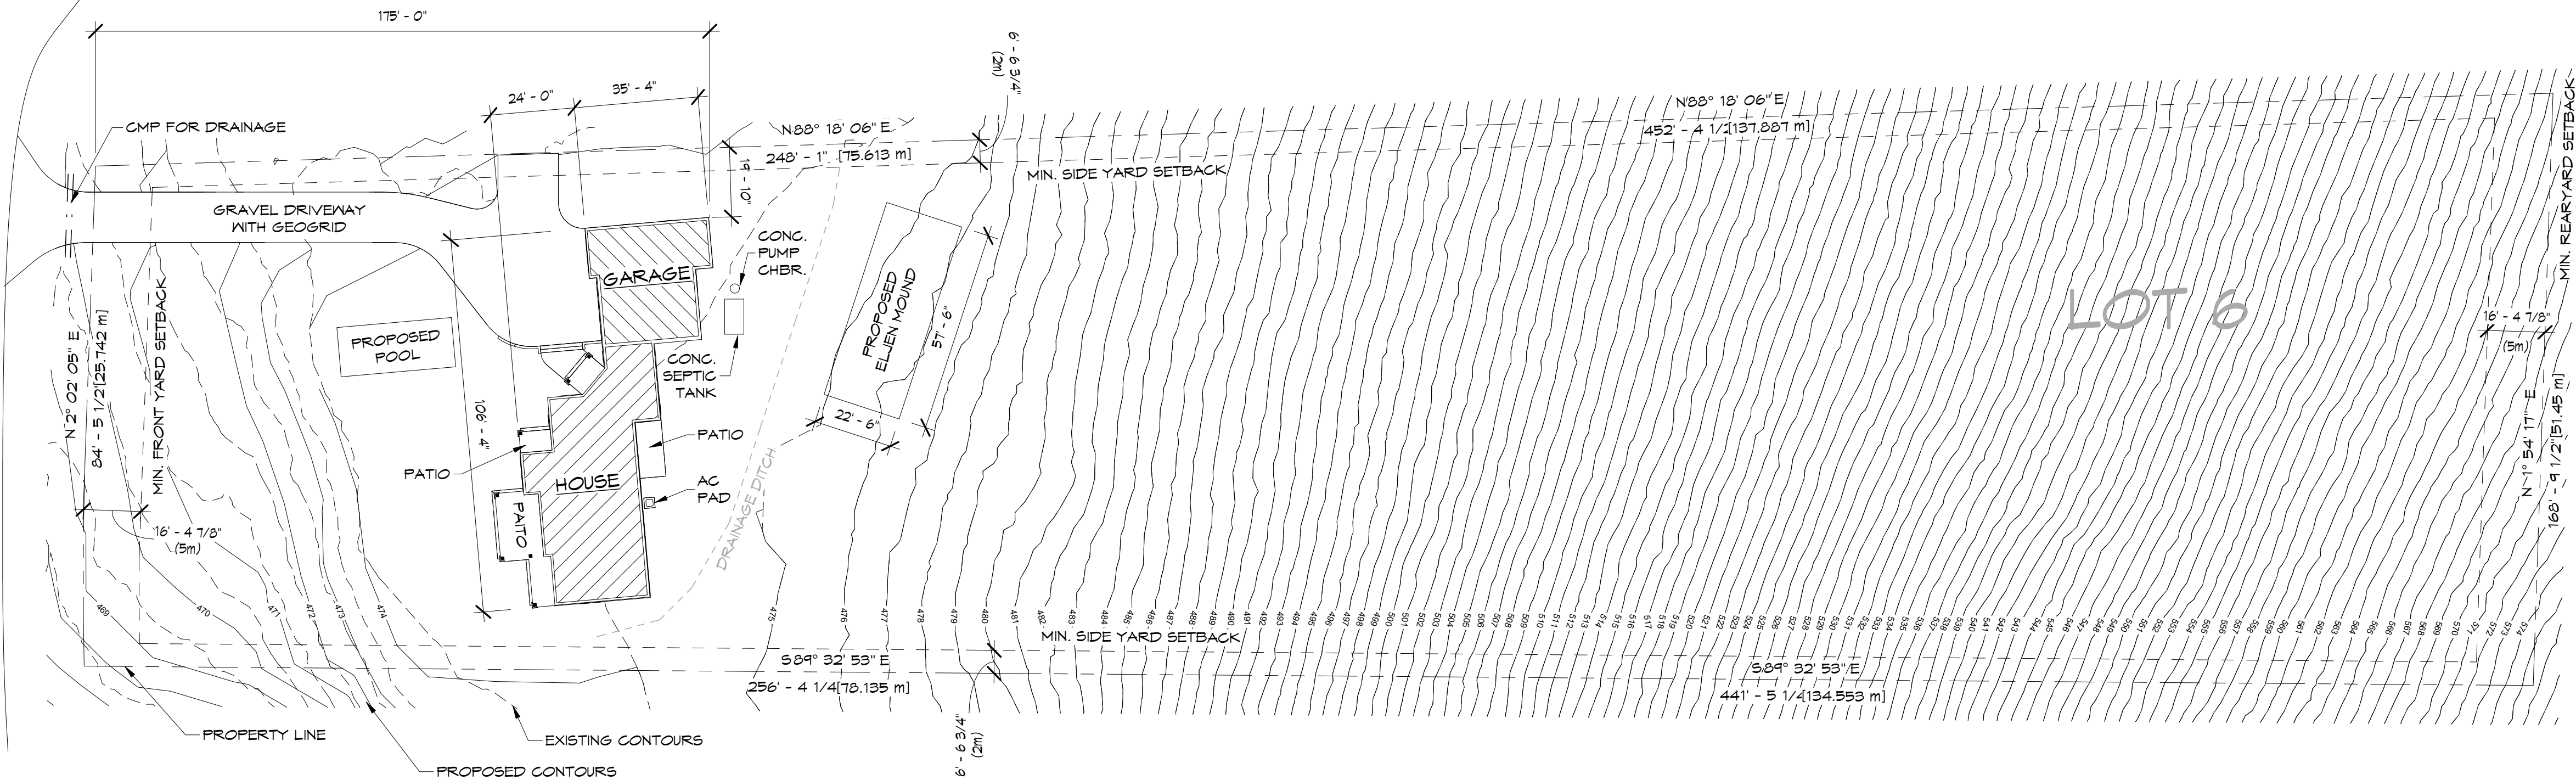

SITE PLAN  
SCALE: 1" = 30'-0"

REVISED 07/27/21  
MONTH DAY YEAR

NO.	REFERENCE DRAWINGS

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5	UPDATED PERMIT ISSUE	16JUL21	I.W.
4	ISSUED FOR PERMIT	08JUN21	I.W.
3	ISSUED FOR PRICING	01MAR21	I.W.
2	ISSUED FOR DP	26FEB21	I.W.

NO.	REVISION	DATE	BY
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#101-1402 McGill Road, Kamloops, BC  
V2C 1L3; 250-828-0321

PROJECT ADKINS CUSTOM	
APPROVED I.W.	
SCALE AS NOTED	
DATE JAN 2021	


CLIENT  
ADKINS, MIKE

TITLE  
SITE PLAN

JOB NUMBER 40K05	A1 OF 12 DWS NO.	5 REV
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CANCEL ALL PRINTS BEARING EARLIER REVISION



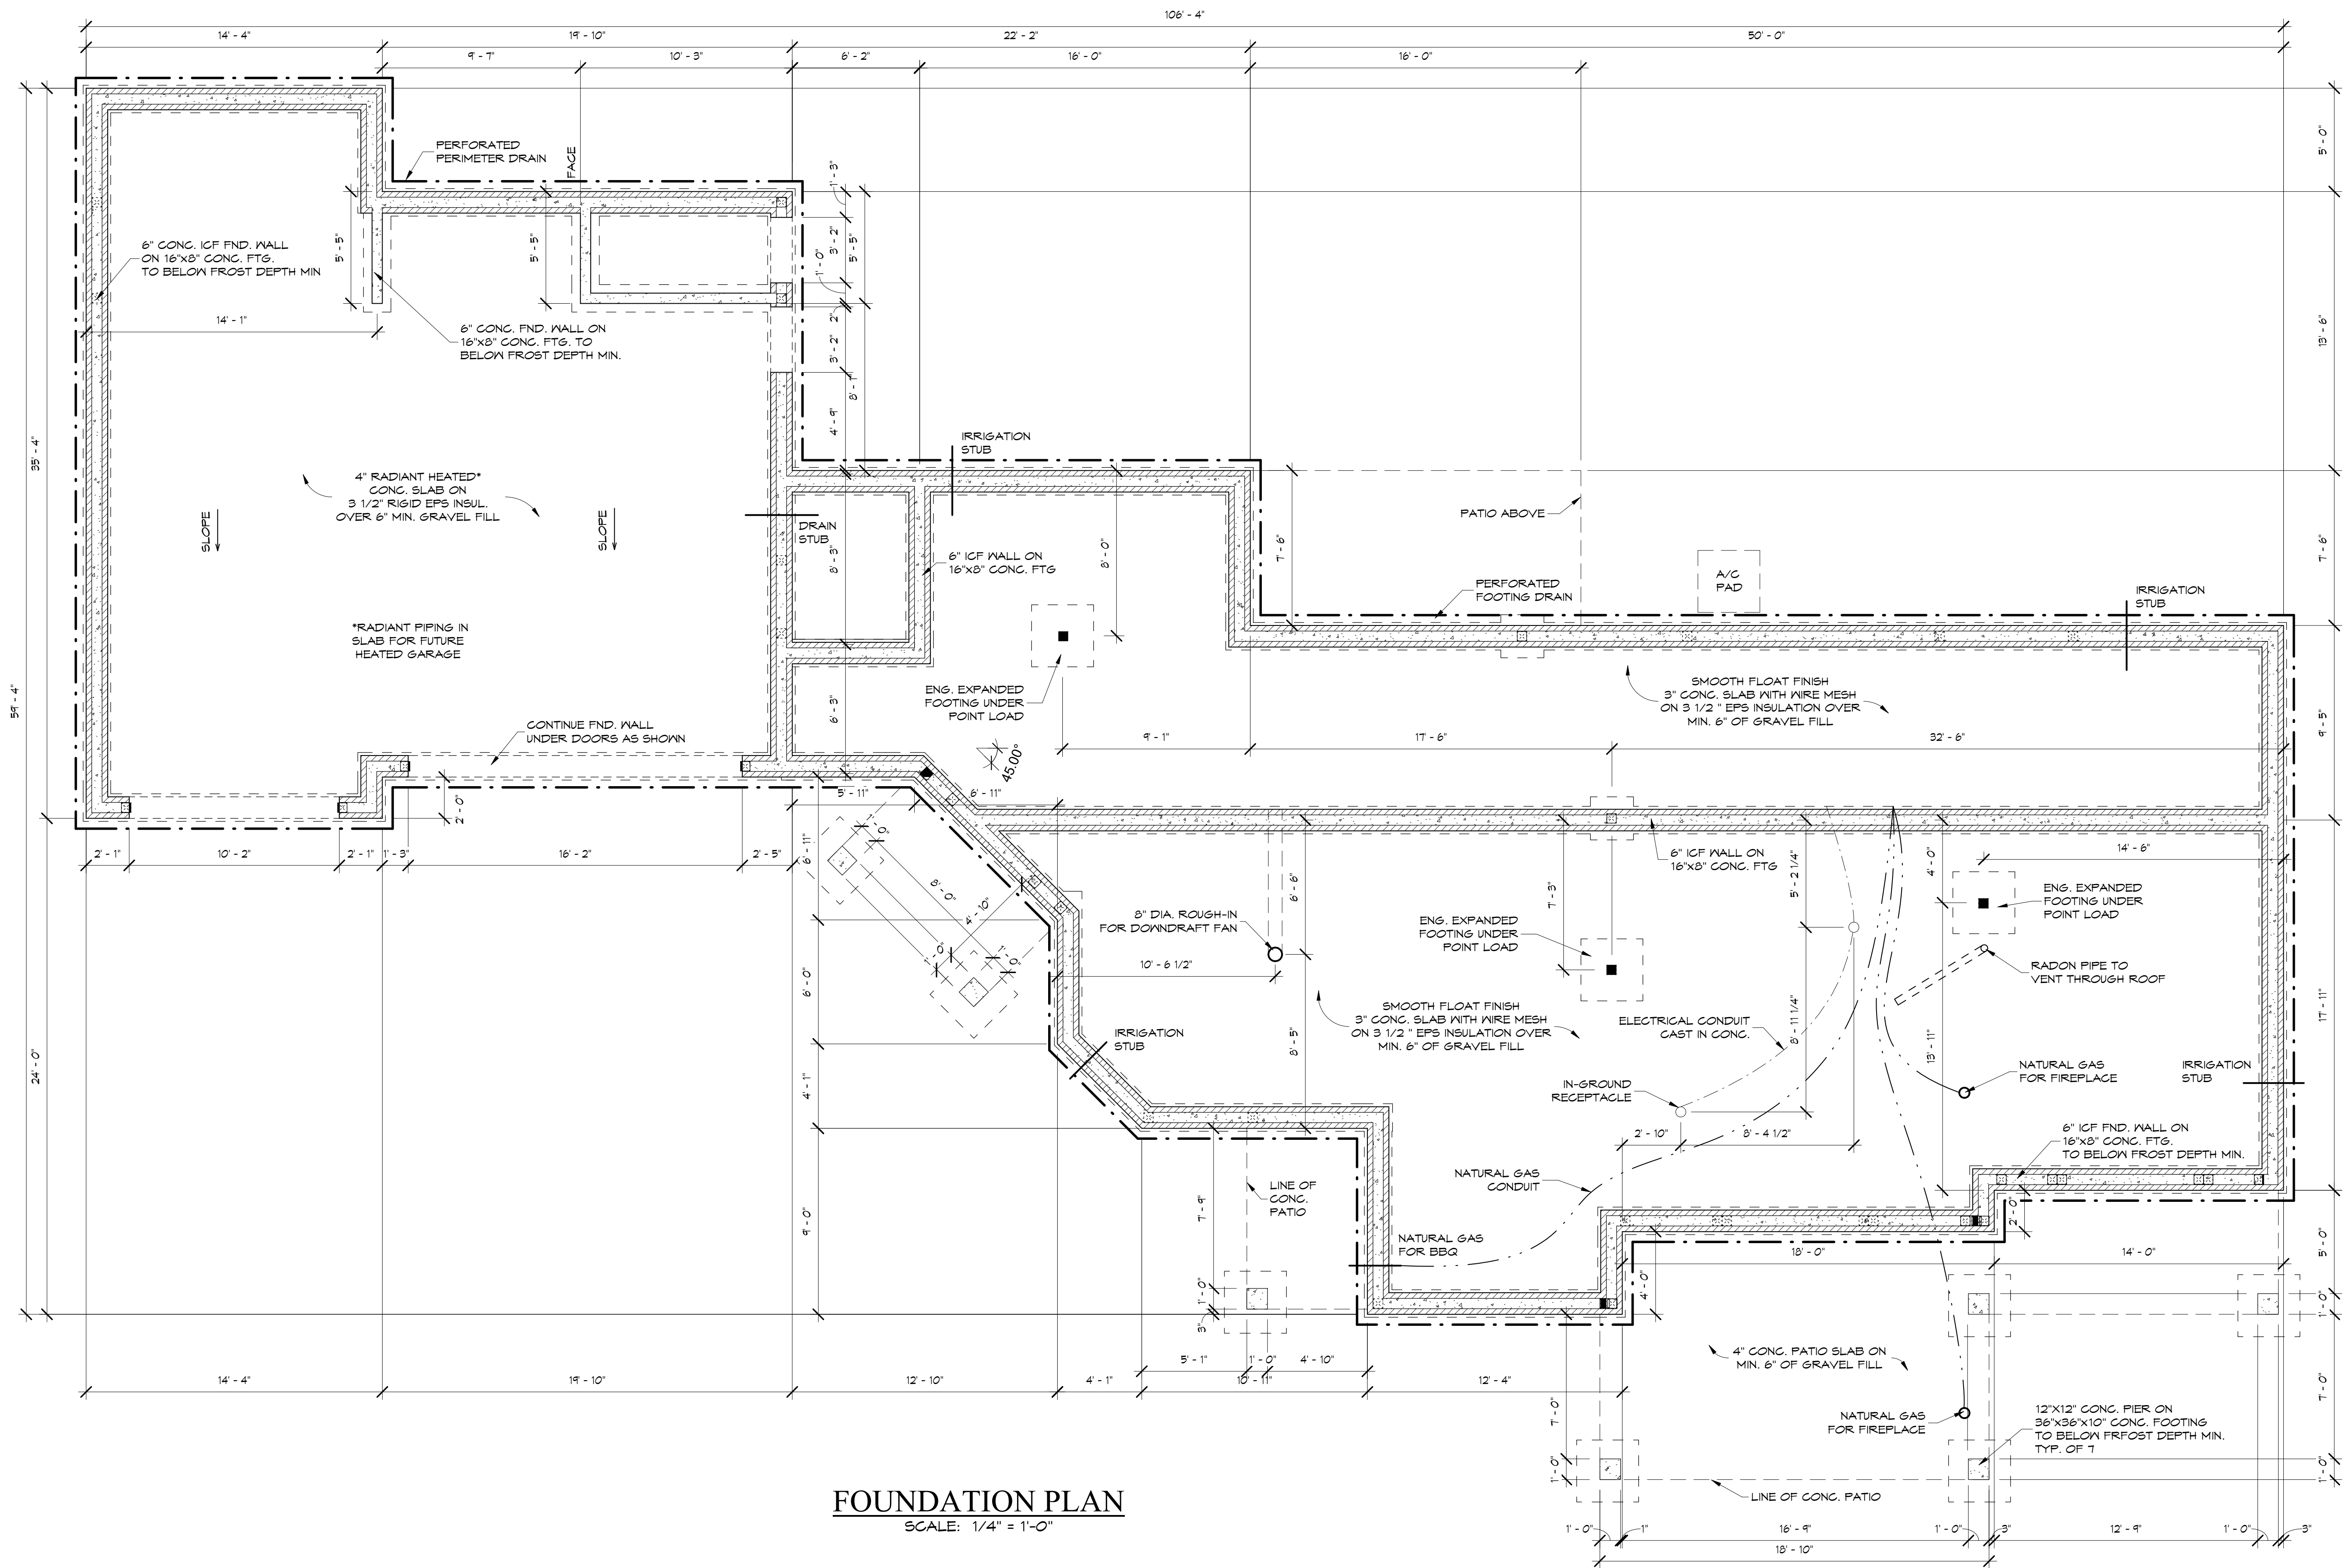

**FOUNDATION PLAN**  
SCALE: 1/4" = 1'-0"

NO.	REFERENCE DRAWINGS

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V2C 1L3; 250-828-0321

<b>A2</b>	PROJECT	ADKINS CUSTOM
	APPROVED	I.W.
	SCALE	AS NOTED
DRAWN S.S.	DATE	JAN 2021


CLIENT  
ADKINS, MIKE

TITLE  
FOUNDATION PLAN

JOB NUMBER 40K05	A2 OF 12 DWS NO.	5 REV
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CANCEL ALL PRINTS BEARING EARLIER REVISION

REVISED 07/27/21  
MONTH DAY YEAR

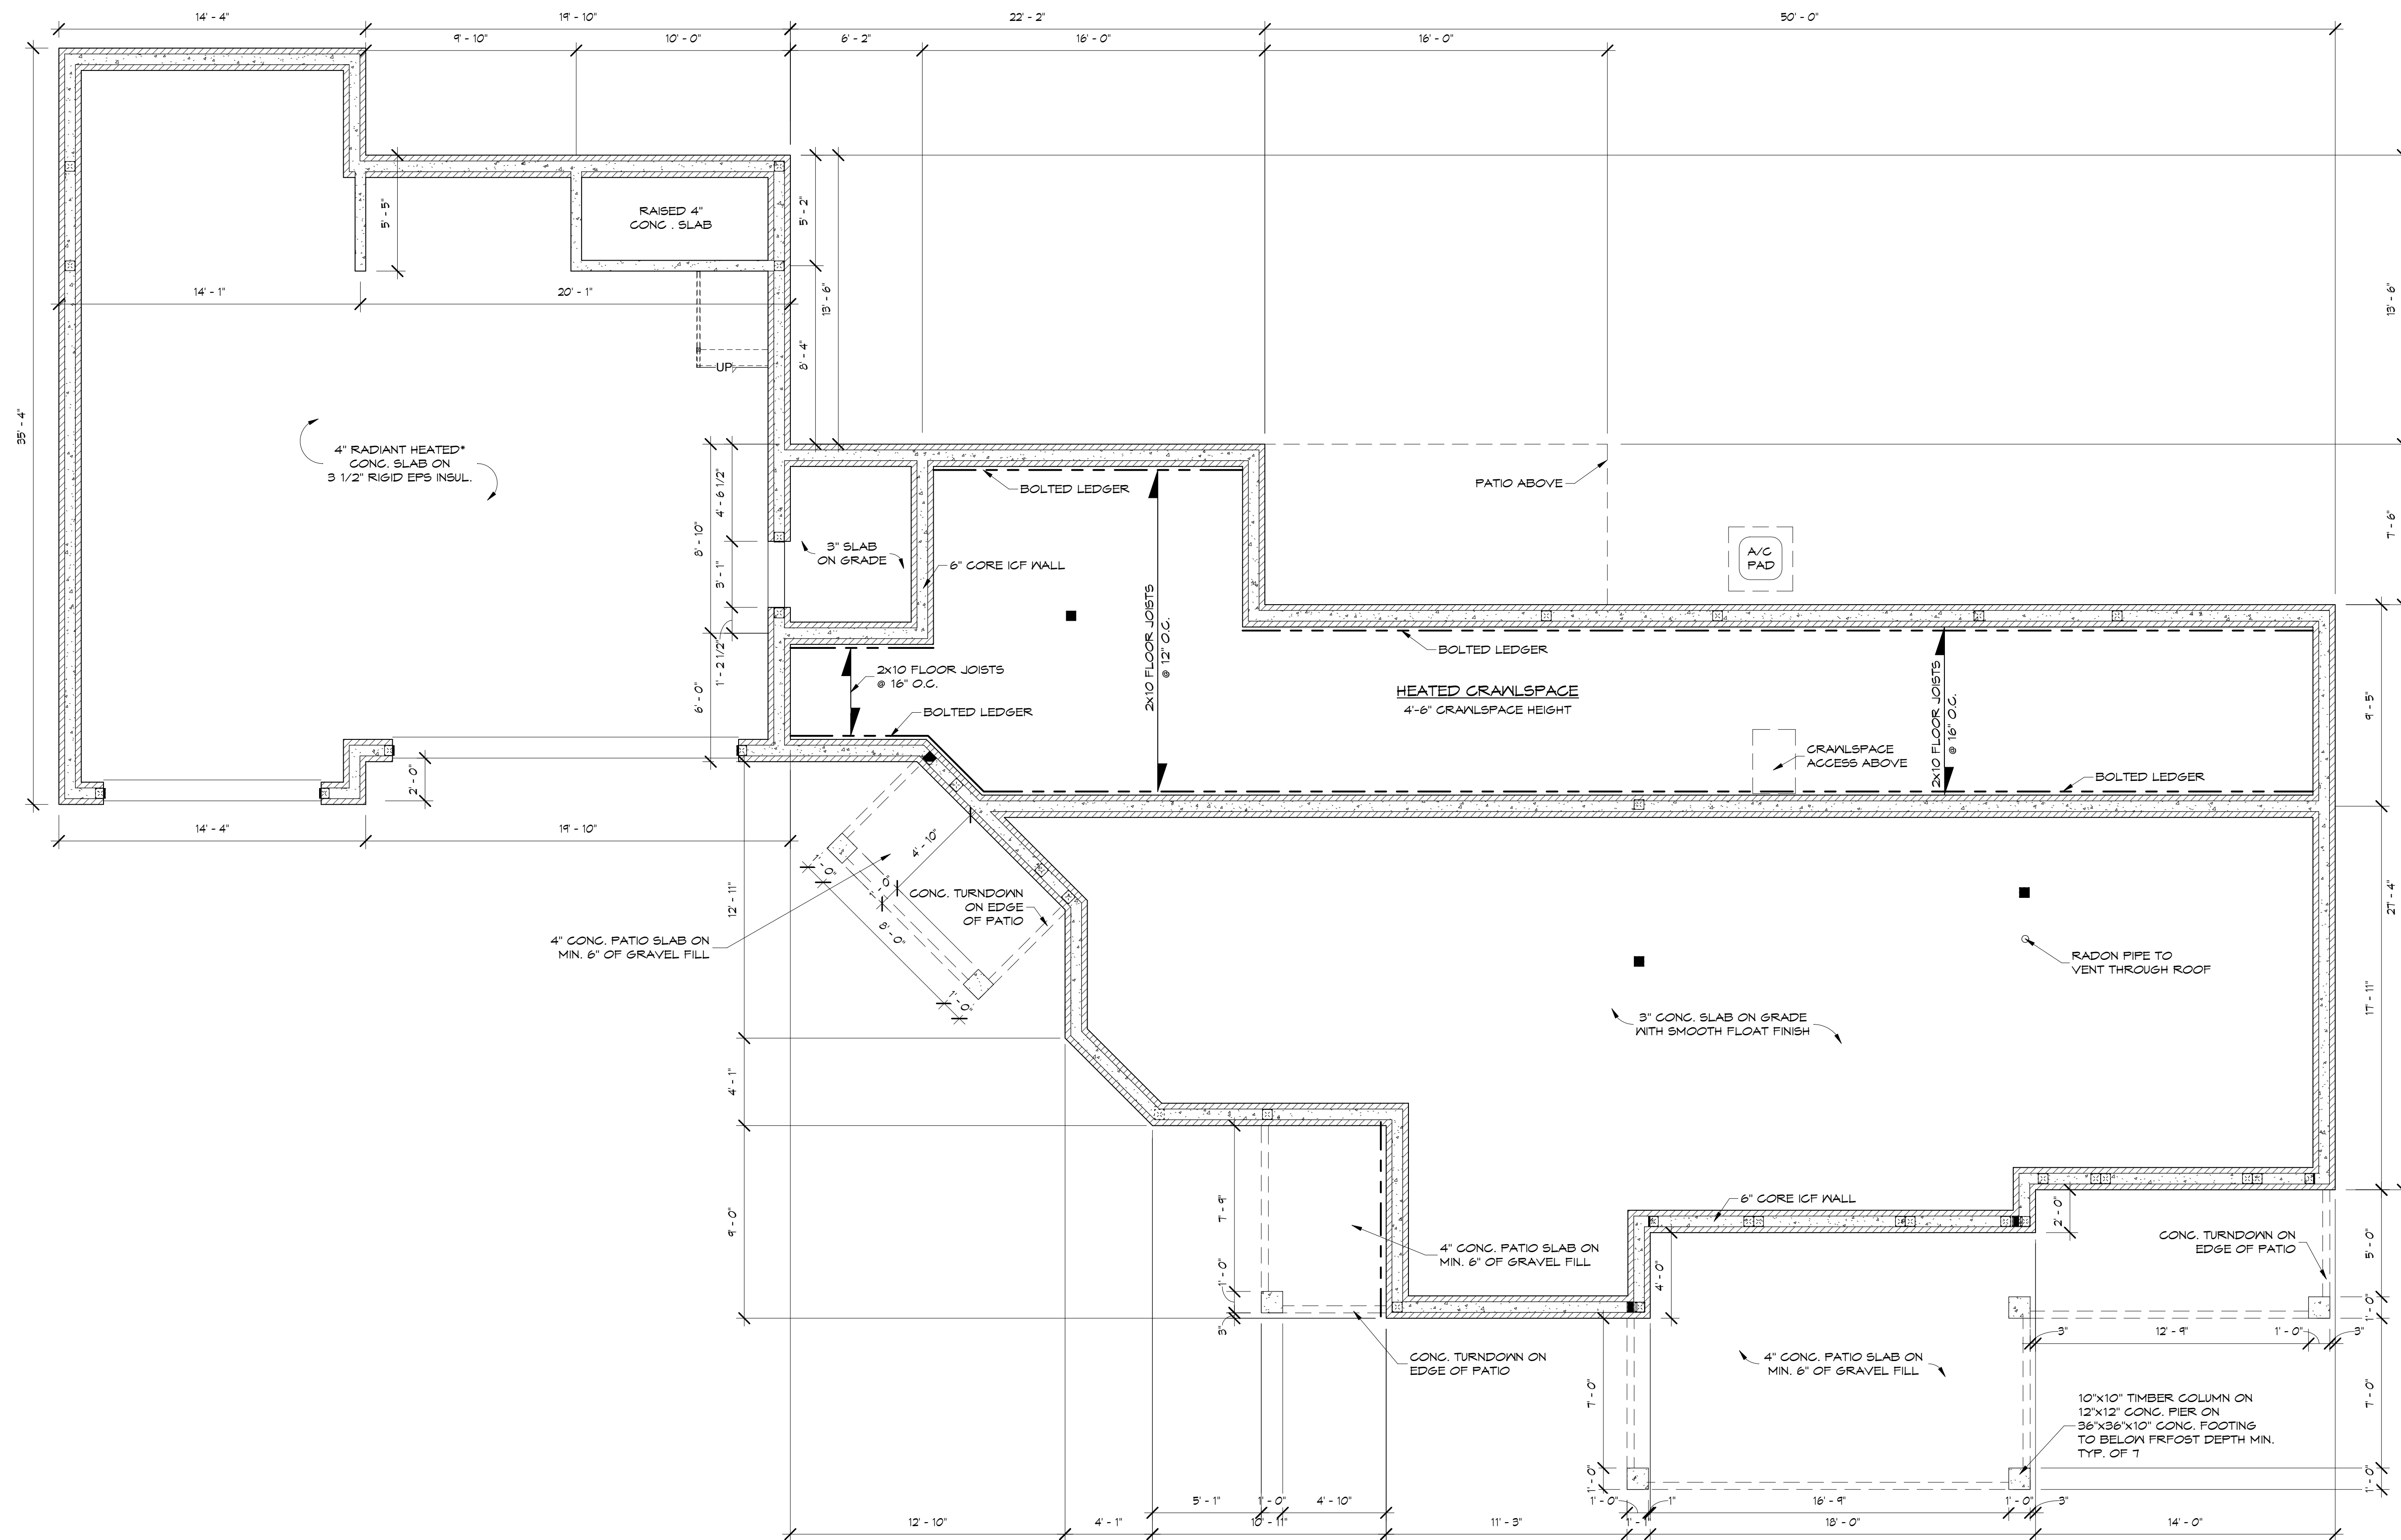

**CRAWLSPACE PLAN**  
SCALE: 1/4" = 1'-0"

REVISED 07/27/21  
MONTH DAY YEAR

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V2C 1L3; 250-828-0321

<b>A3</b>	PROJECT	ADKINS CUSTOM
	APPROVED	I.W.
	SCALE	AS NOTED
	DATE	JAN 2021


CLIENT  
ADKINS, MIKE

TITLE  
CRAWLSPACE PLAN

JOB NUMBER	40K05	A3 OF 12	5
		DWG NO.	REV

CANCEL ALL PRINTS BEARING EARLIER REVISION



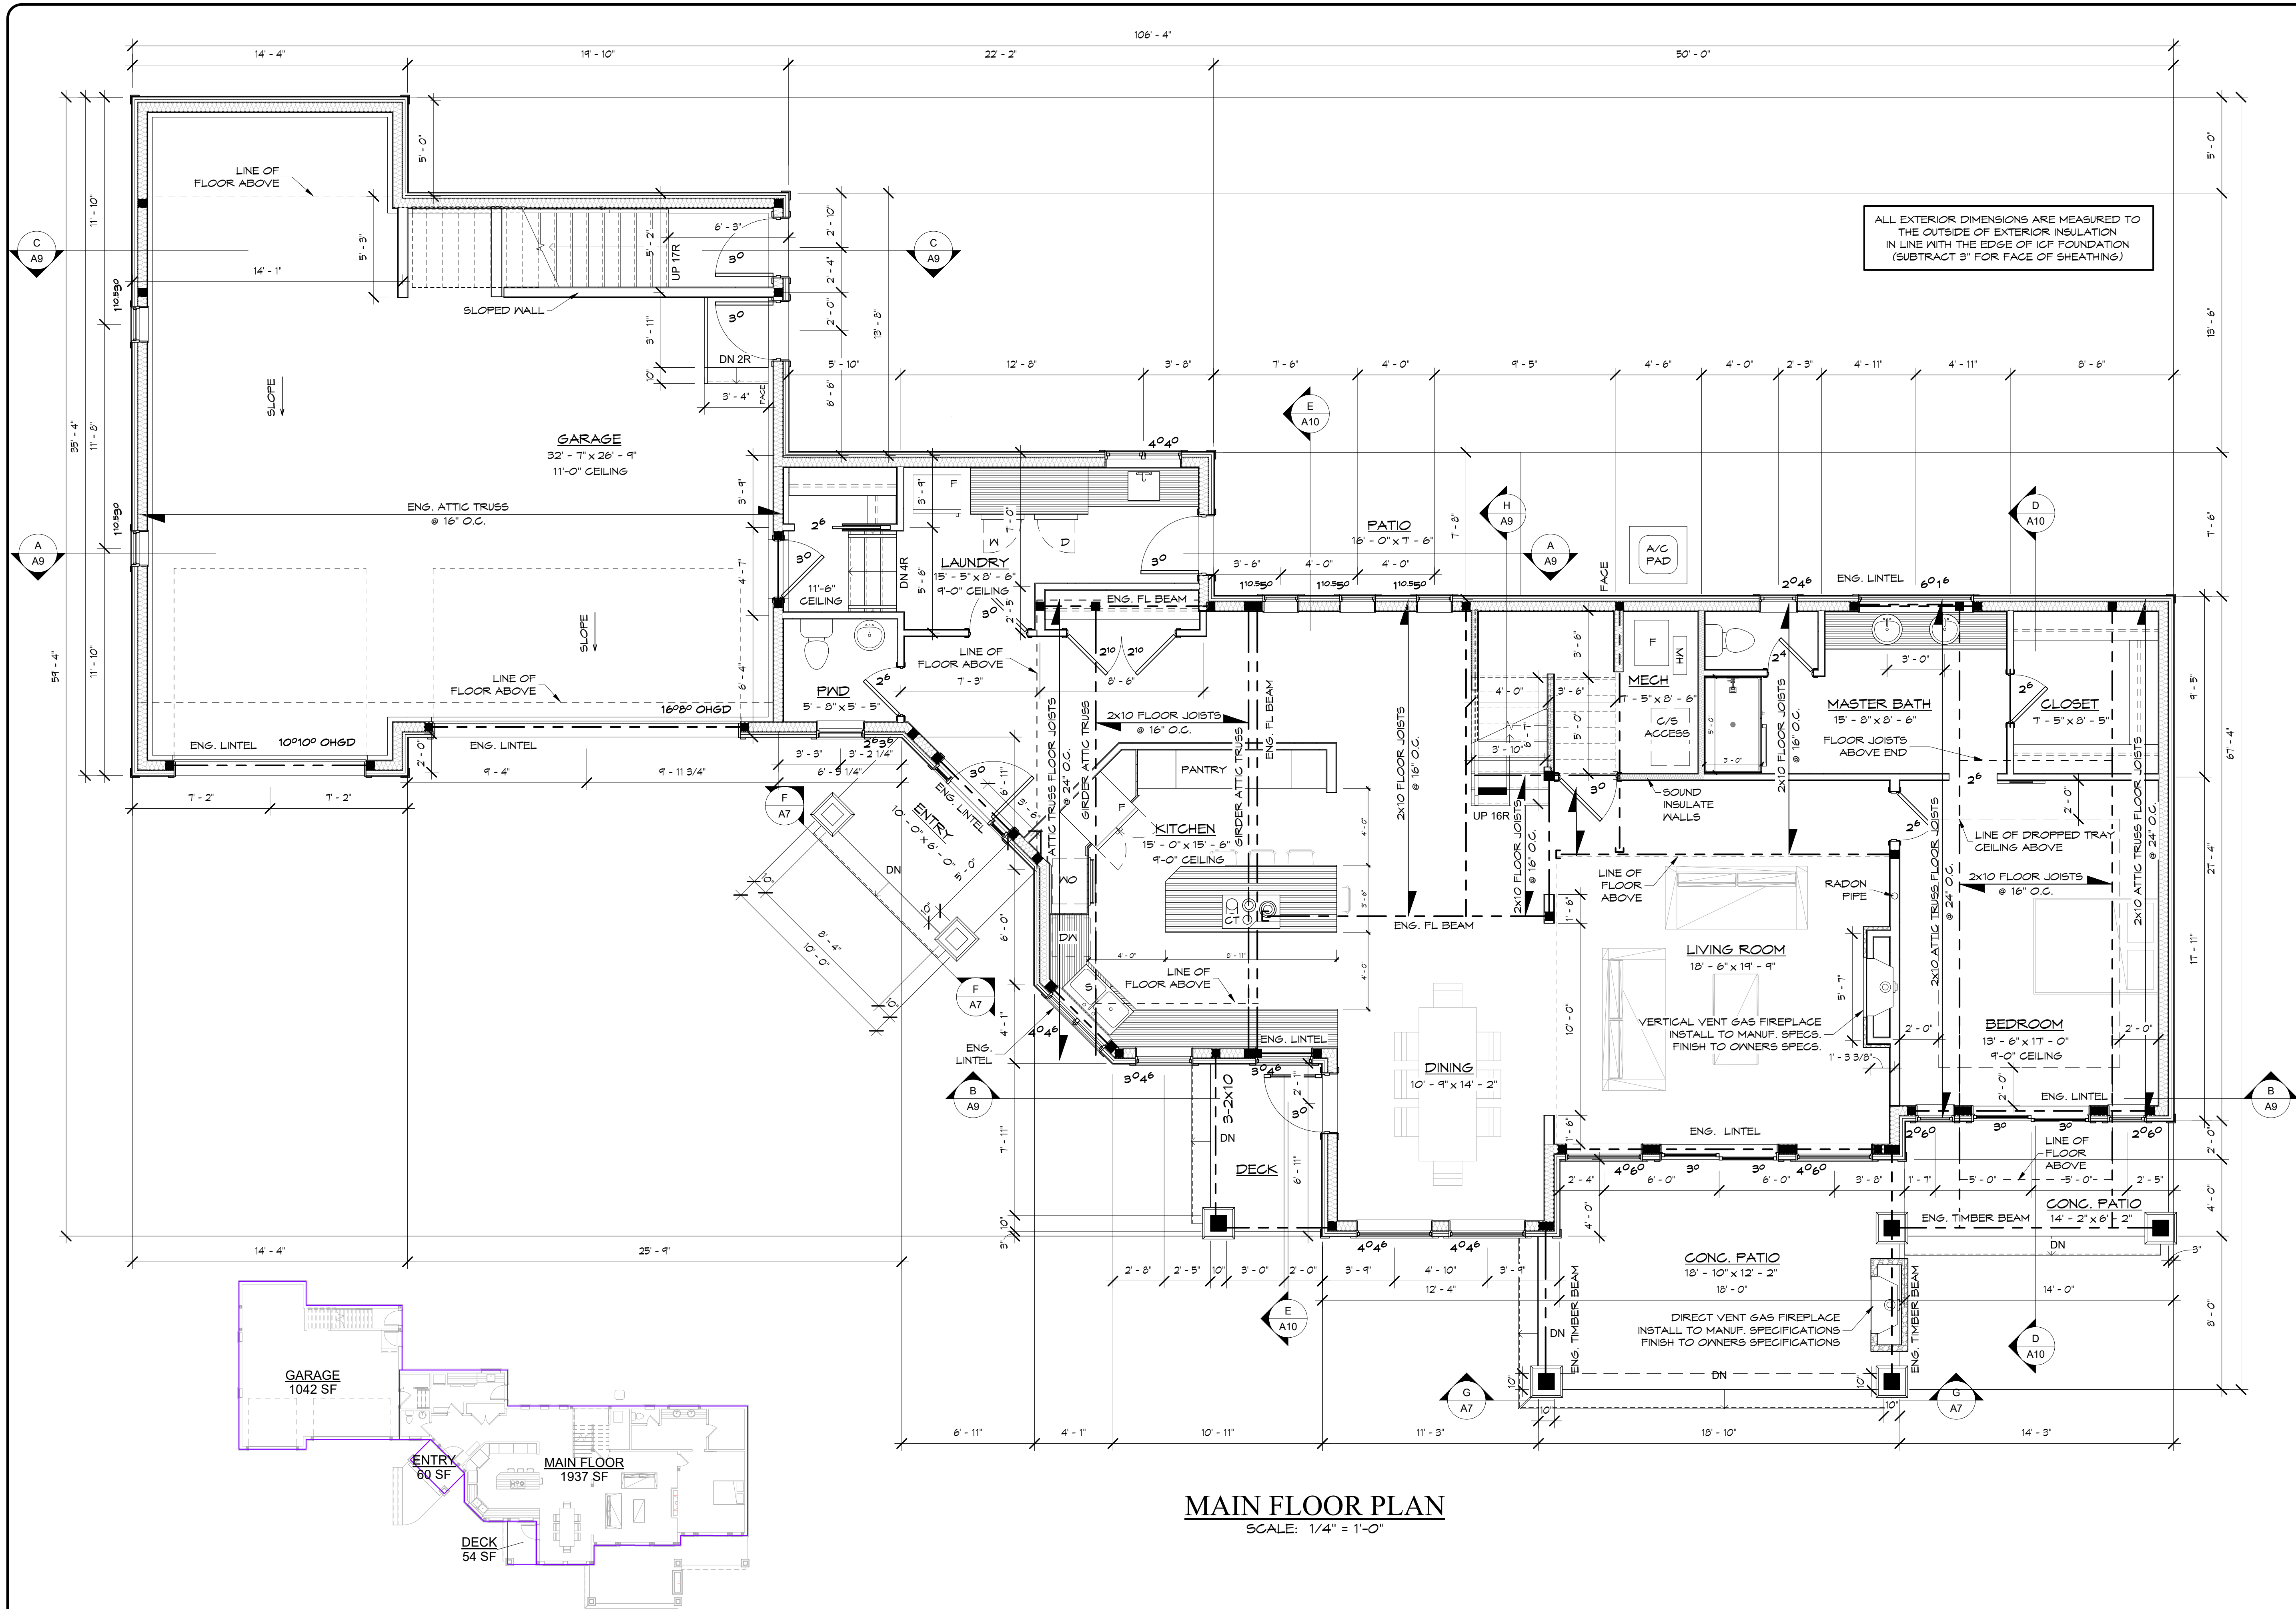

MAIN FLOOR AREA PLAN  
SCALE: 1/16" = 1'-0"

MAIN FLOOR PLAN  
SCALE: 1/4" = 1'-0"

REVISED 07/27/21  
MONTH DAY YEAR

NO.	REFERENCE DRAWINGS

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1	ISSUED FOR REVIEW	11FEB21	I.W.



#101-1402 McGill Road, Kamloops, BC  
V2C 1L3; 250-828-0321


A4	PROJECT	ADKINS CUSTOM
	APPROVED	I.W.
	SCALE	AS NOTED
	DATE	JAN 2021

CLIENT  
ADKINS, MIKE

TITLE  
MAIN FLOOR PLAN

JOB NUMBER	40K05	A4 OF 12 DWS NO.	5 REV
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CANCEL ALL PRINTS BEARING EARLIER REVISION

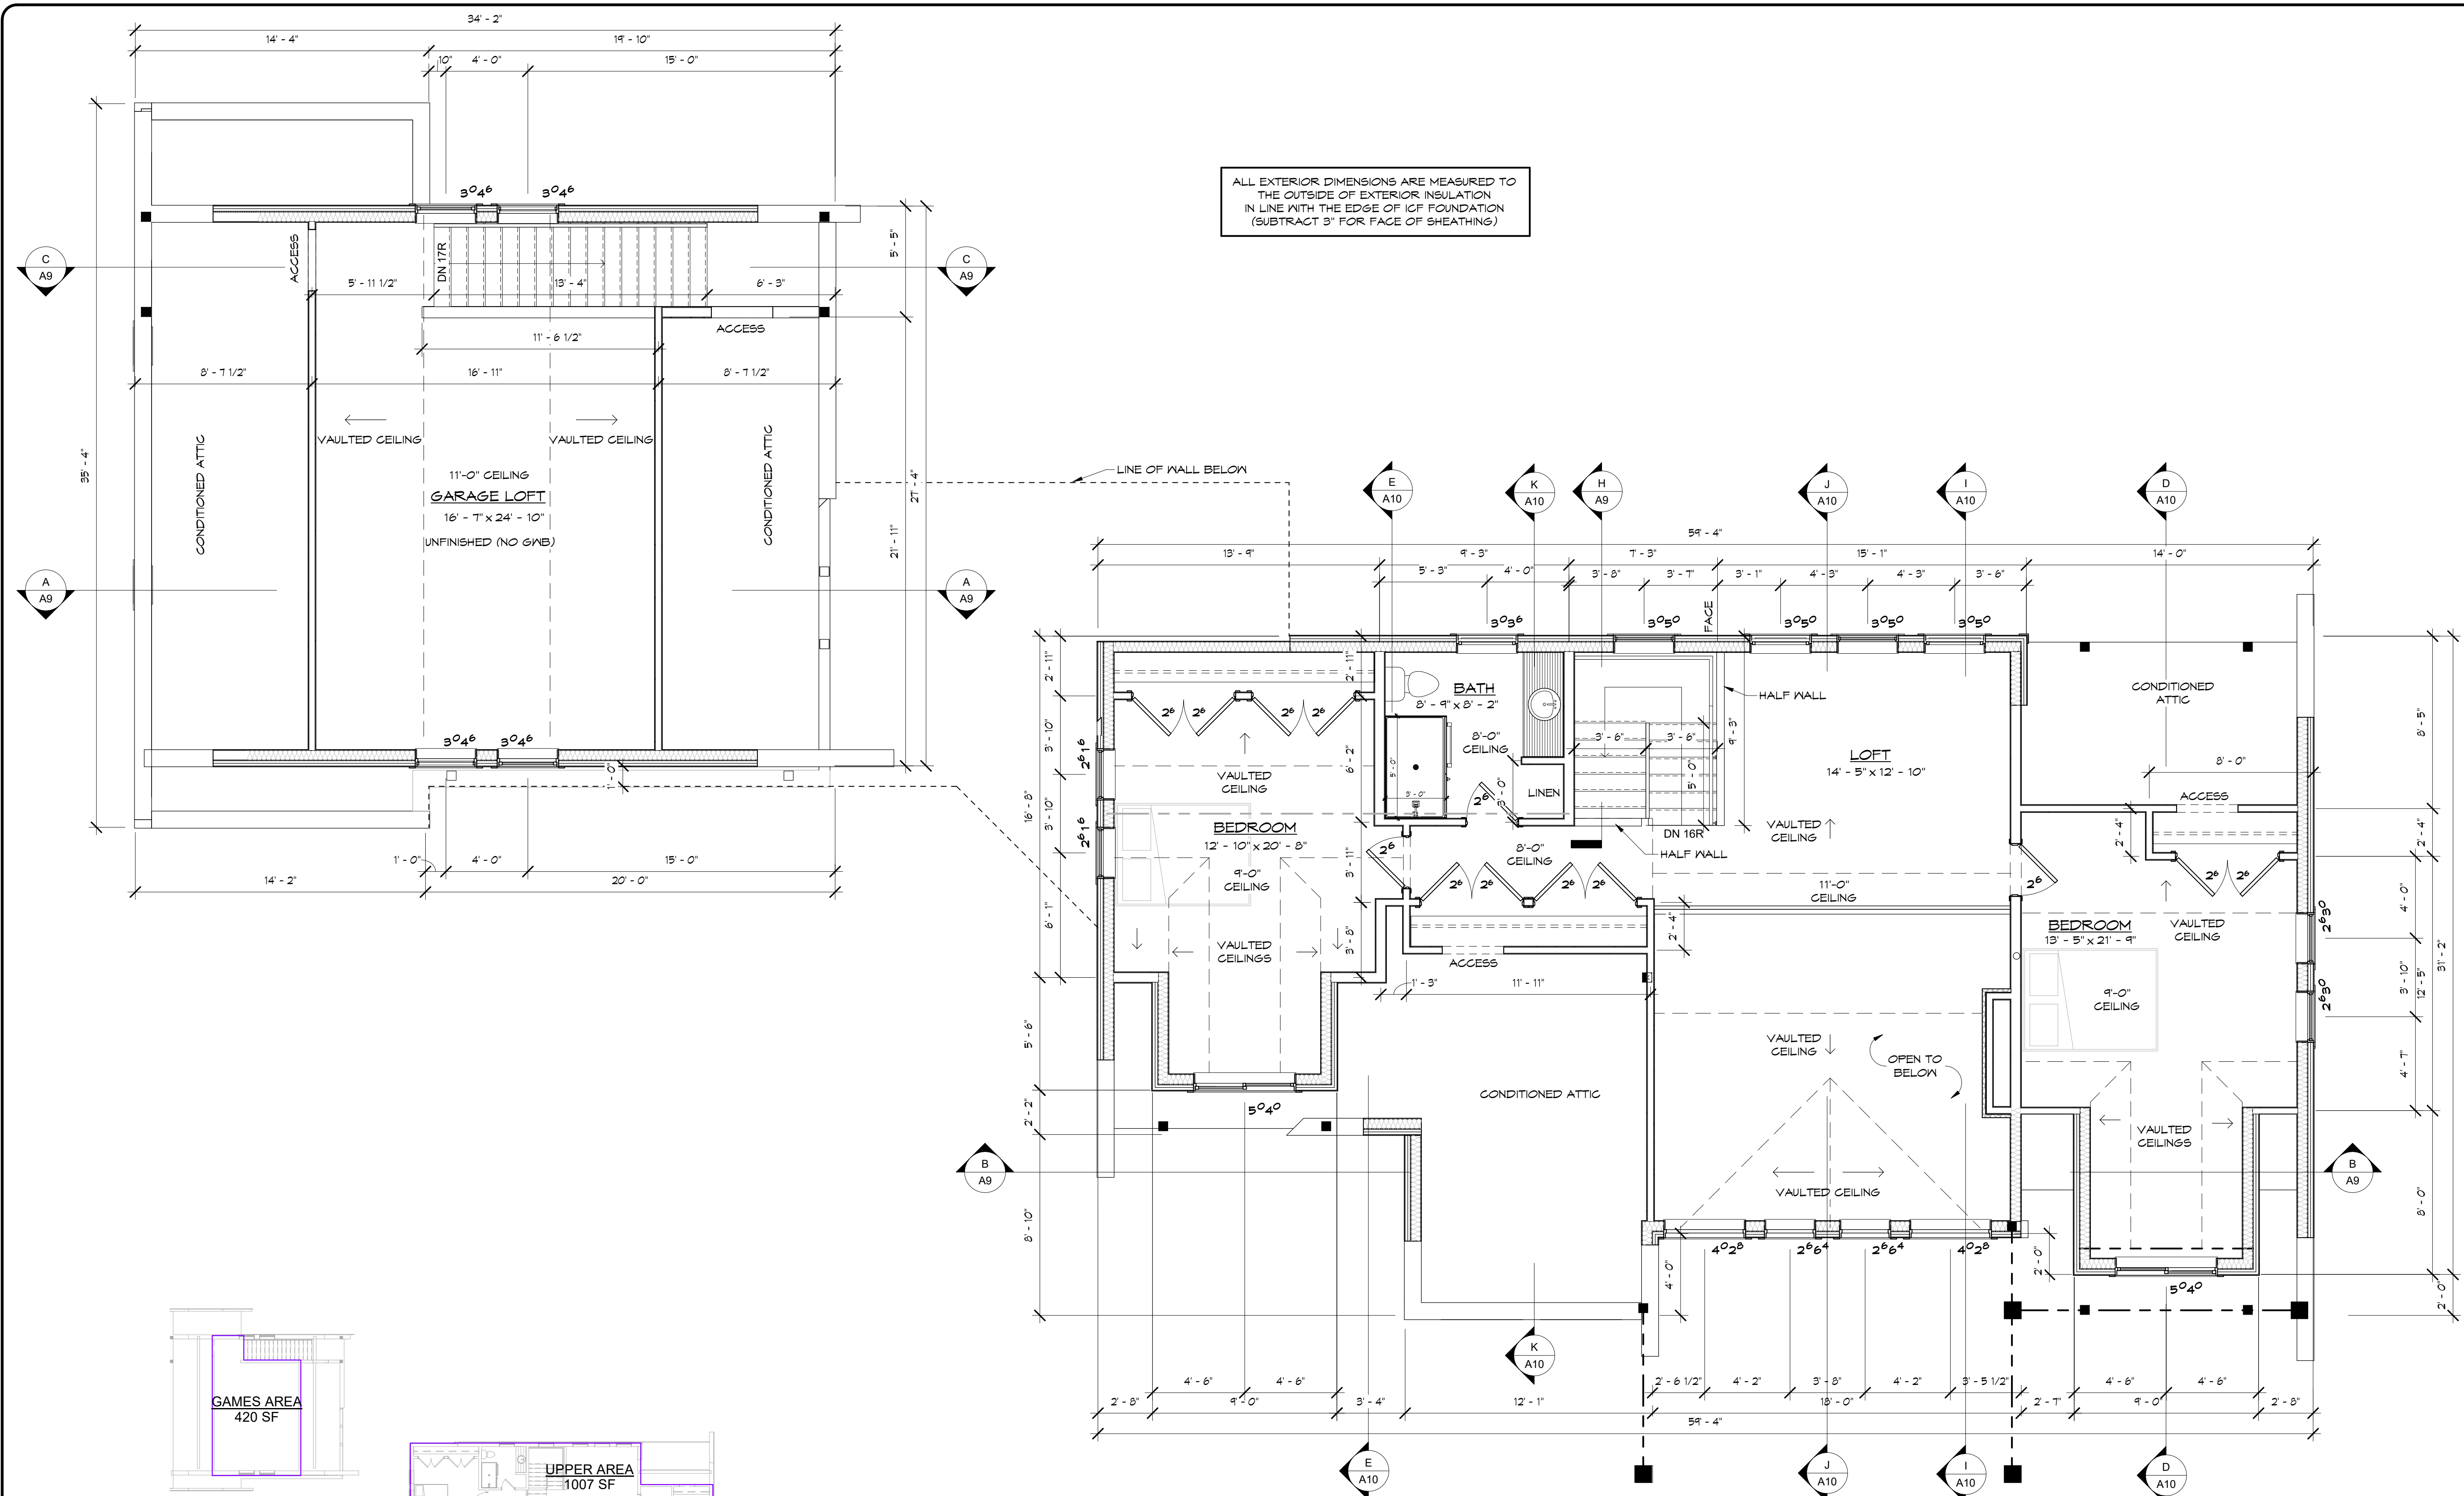

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#101-1402 McGill Road, Kamloops, BC  
V2C 1L3; 250-828-0321

<b>A5</b>	PROJECT	ADKINS CUSTOM
	APPROVED	I.W.
	SCALE	AS NOTED
DRAWN S.S.	DATE	JAN 2021

CLIENT  
ADKINS, MIKE

TITLE  
UPPER FLOOR PLAN

JOB NUMBER 40K05	A5 OF 12 DWS NO.	5 REV
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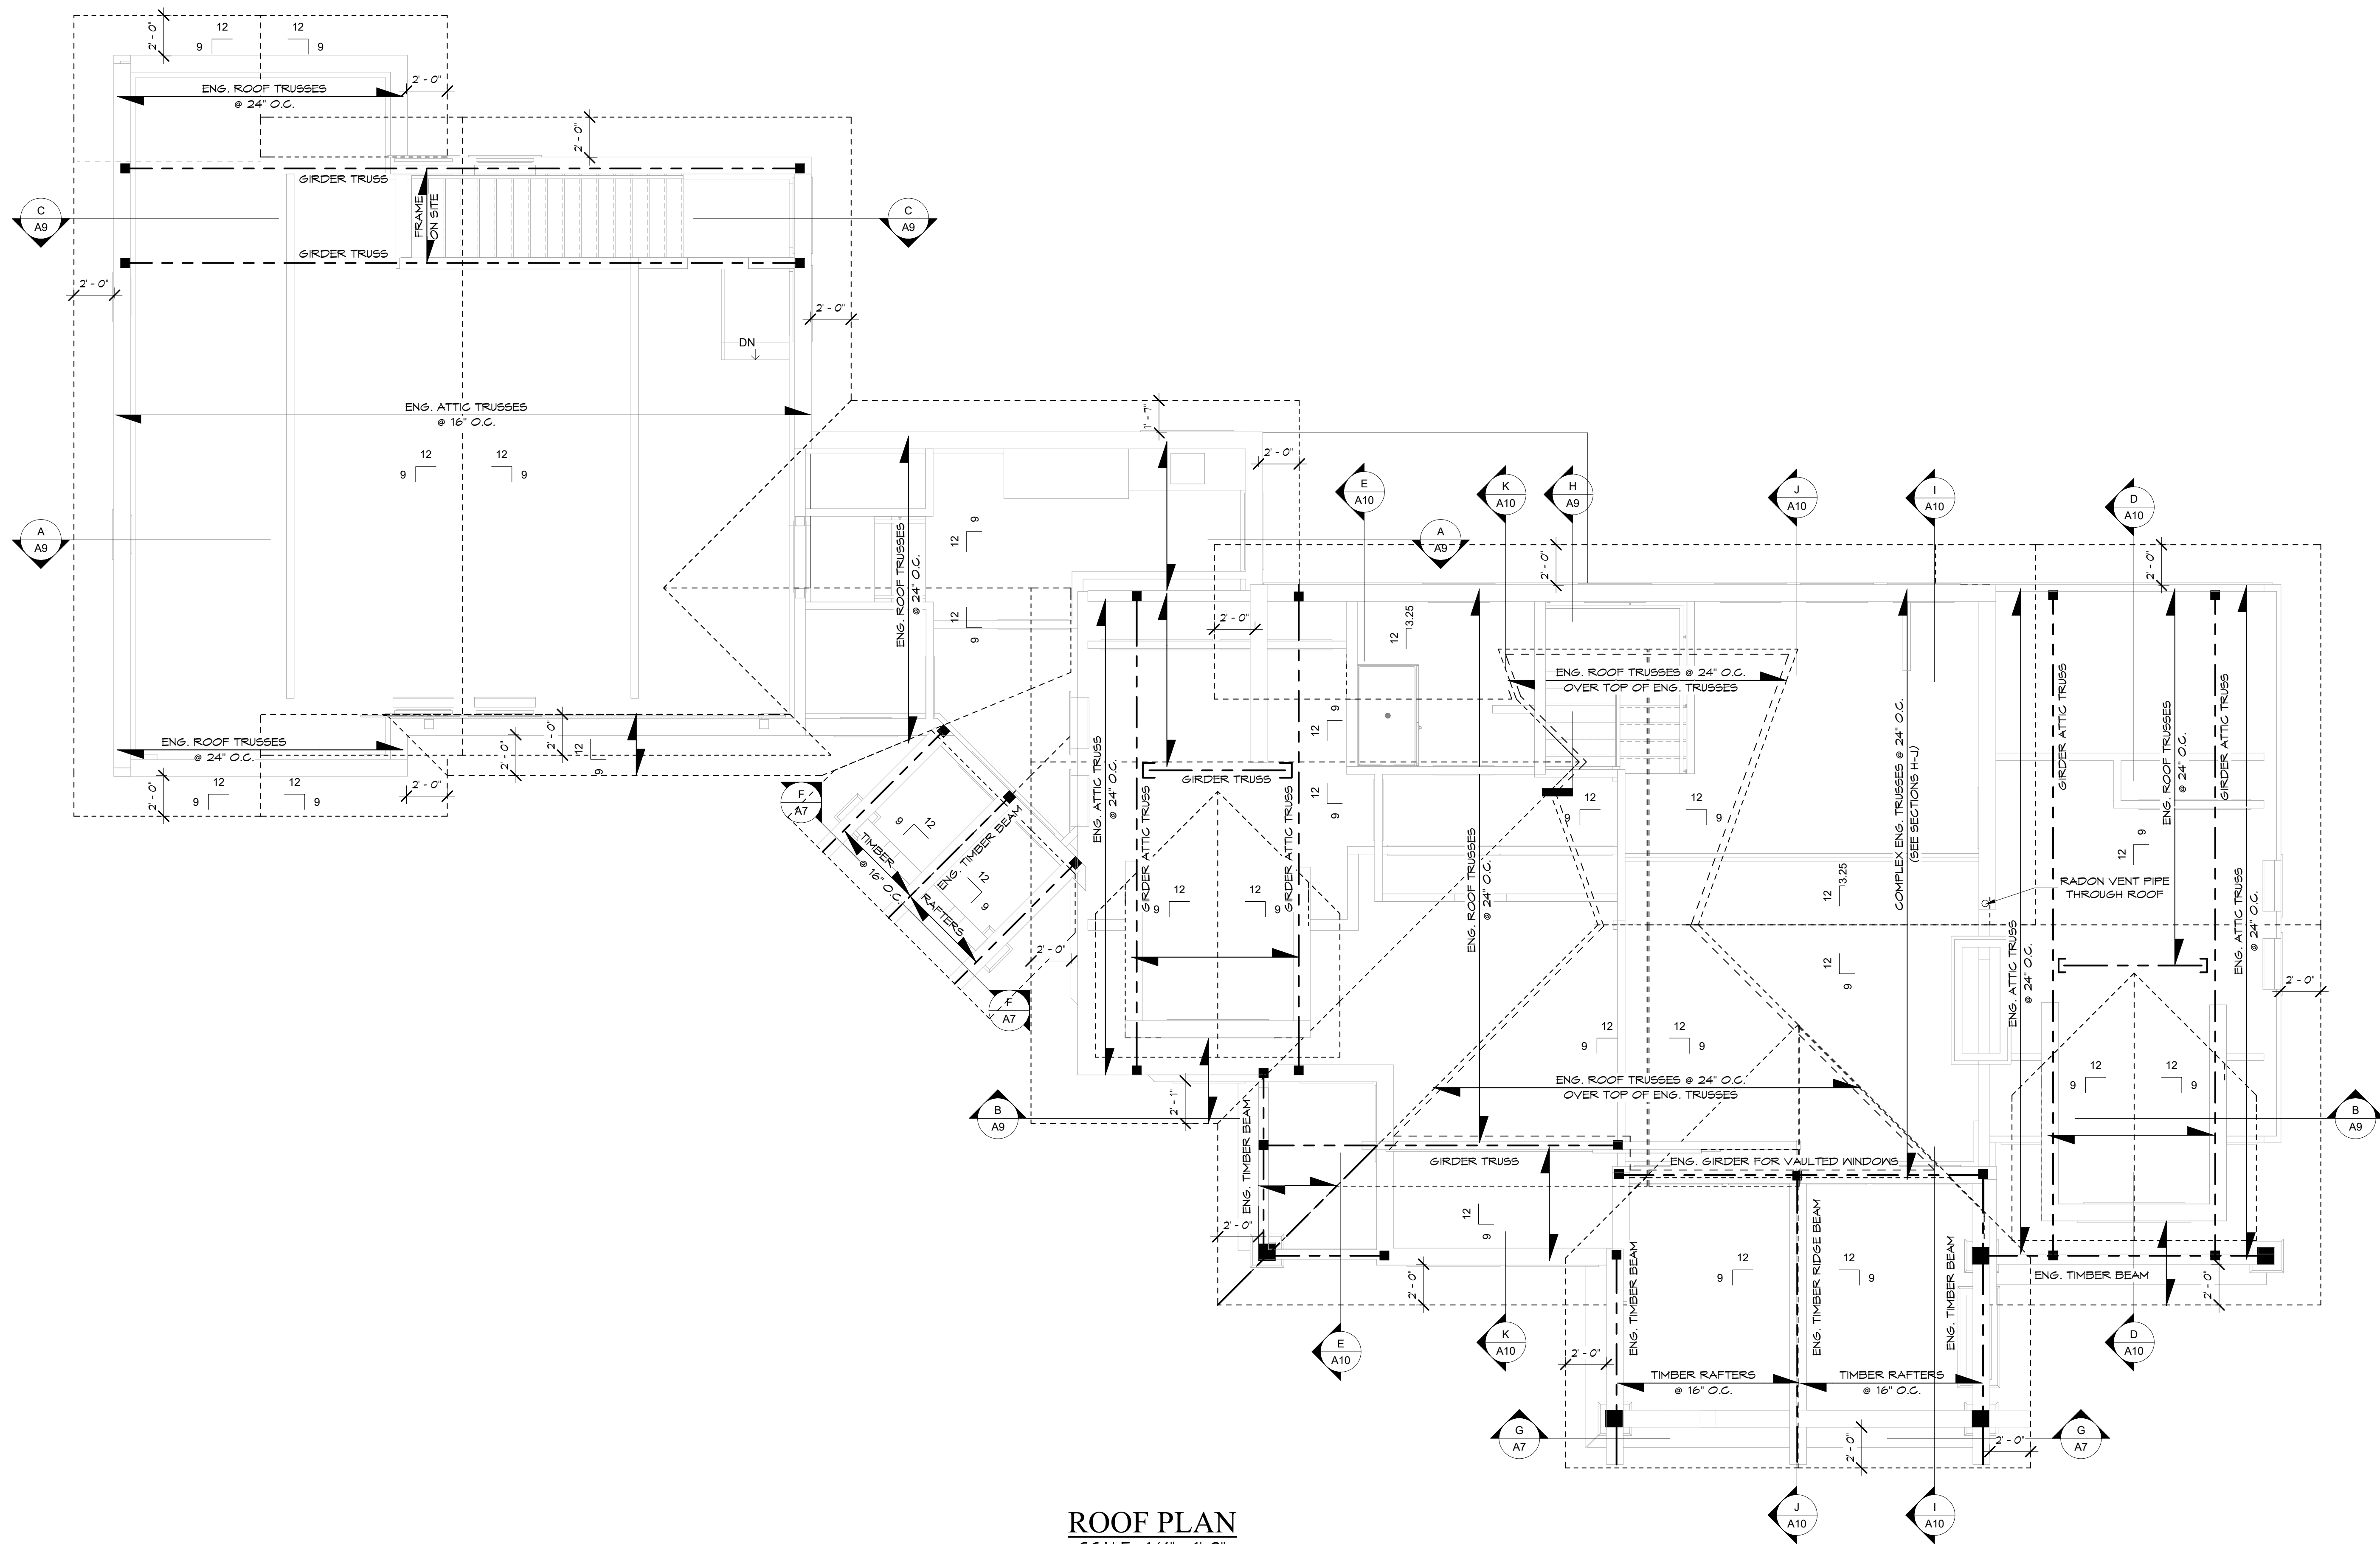
CANCEL ALL PRINTS BEARING EARLIER REVISION

**UPPER FLOOR AREA PLAN**  
SCALE: 1/16" = 1'-0"

**UPPER FLOOR PLAN**  
SCALE: 1/4" = 1'-0"

REVISED 07/27/21  
MONTH DAY YEAR





ROOF PLAN  
SCALE: 1/4" = 1'-0"

NO.	REFERENCE DRAWINGS

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#101-1402 McGill Road, Kamloops, BC  
V2C 1L3; 250-828-0321

<b>A6</b>	PROJECT	ADKINS CUSTOM
	APPROVED	I.W.
	SCALE	AS NOTED
	DATE	JAN 2021

CLIENT  
ADKINS, MIKE

TITLE  
ROOF PLAN


JOB NUMBER	40K05	A6 OF 12	5
		DWG NO.	REV

CANCEL ALL PRINTS BEARING EARLIER REVISION


REVISED 07/27/21  
MONTH DAY YEAR





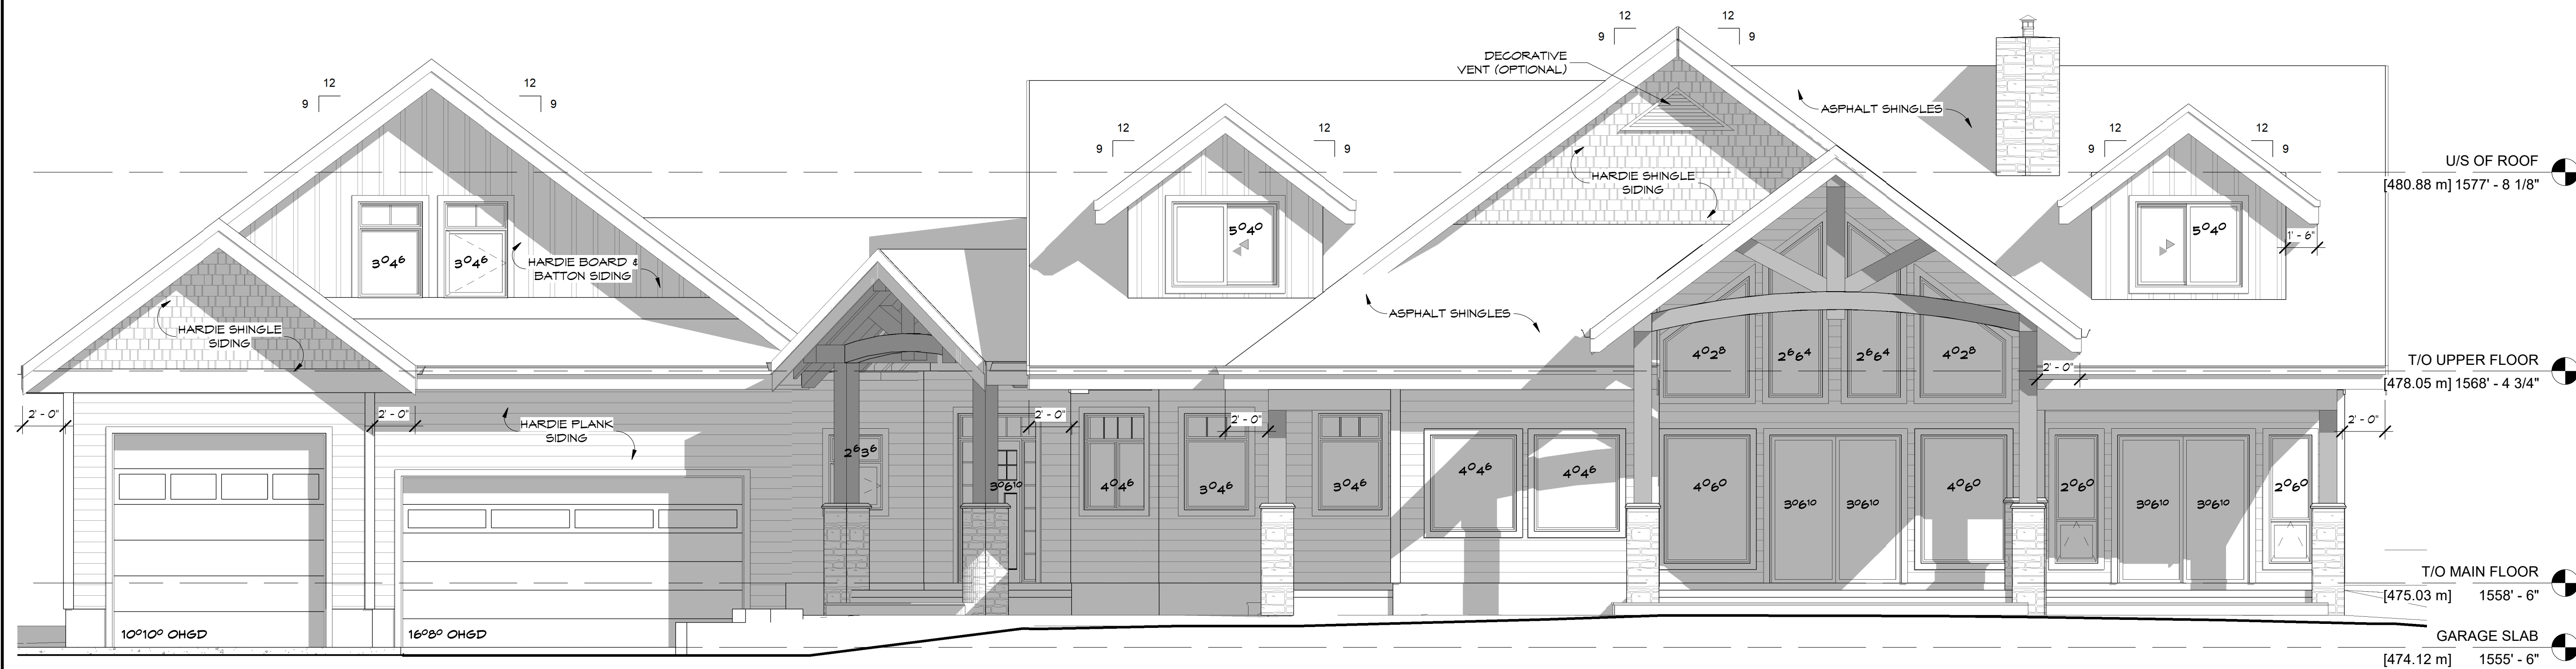

**WEST (FRONT) ELEVATION**  
SCALE: 1/4" = 1'-0"

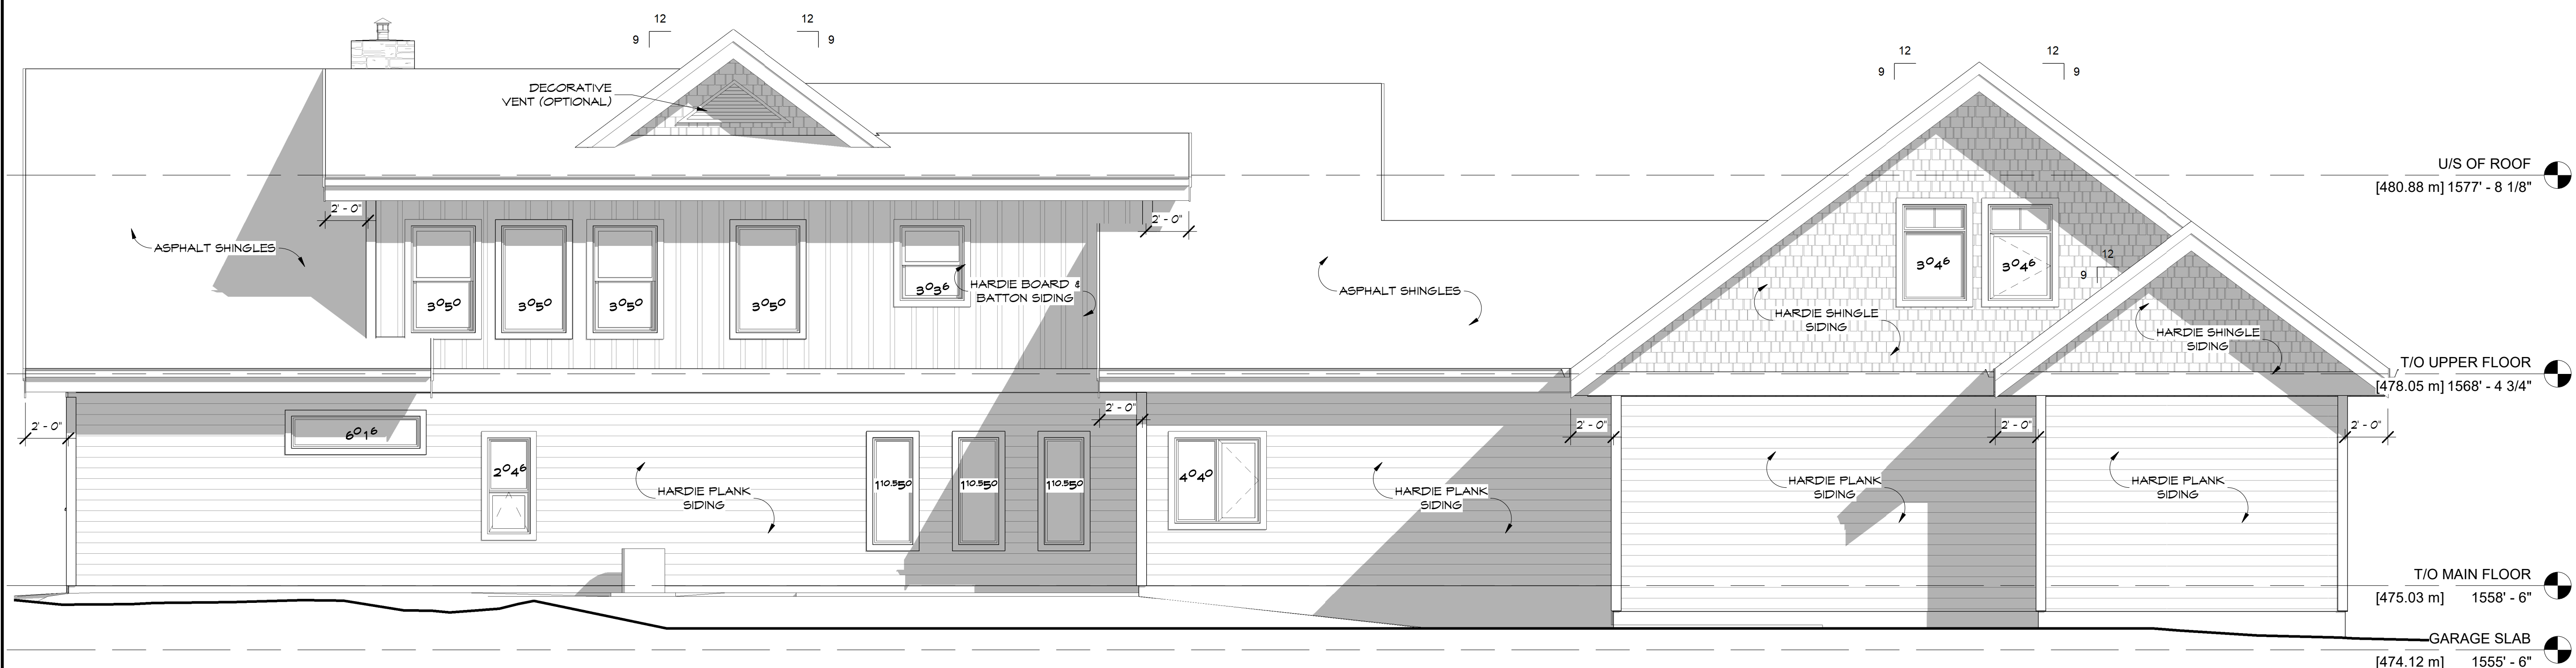

**EAST (REAR) ELEVATION**  
SCALE: 1/4" = 1'-0"

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**PROCAD  
DESIGNS**  
#101-1402 McGill Road, Kamloops, BC  
V2C 1L3; 250-828-0321

**A8**  
DRAWN: S.S.  
FILE:

PROJECT: ADKINS CUSTOM  
APPROVED: I.W.  
SCALE: AS NOTED  
DATE: JAN 2021


CLIENT: ADKINS, MIKE

TITLE: EAST AND WEST ELEVATIONS


JOB NUMBER	A8 OF 12	5
40K05	DWG NO.	REV

CANCEL ALL PRINTS BEARING EARLIER REVISION




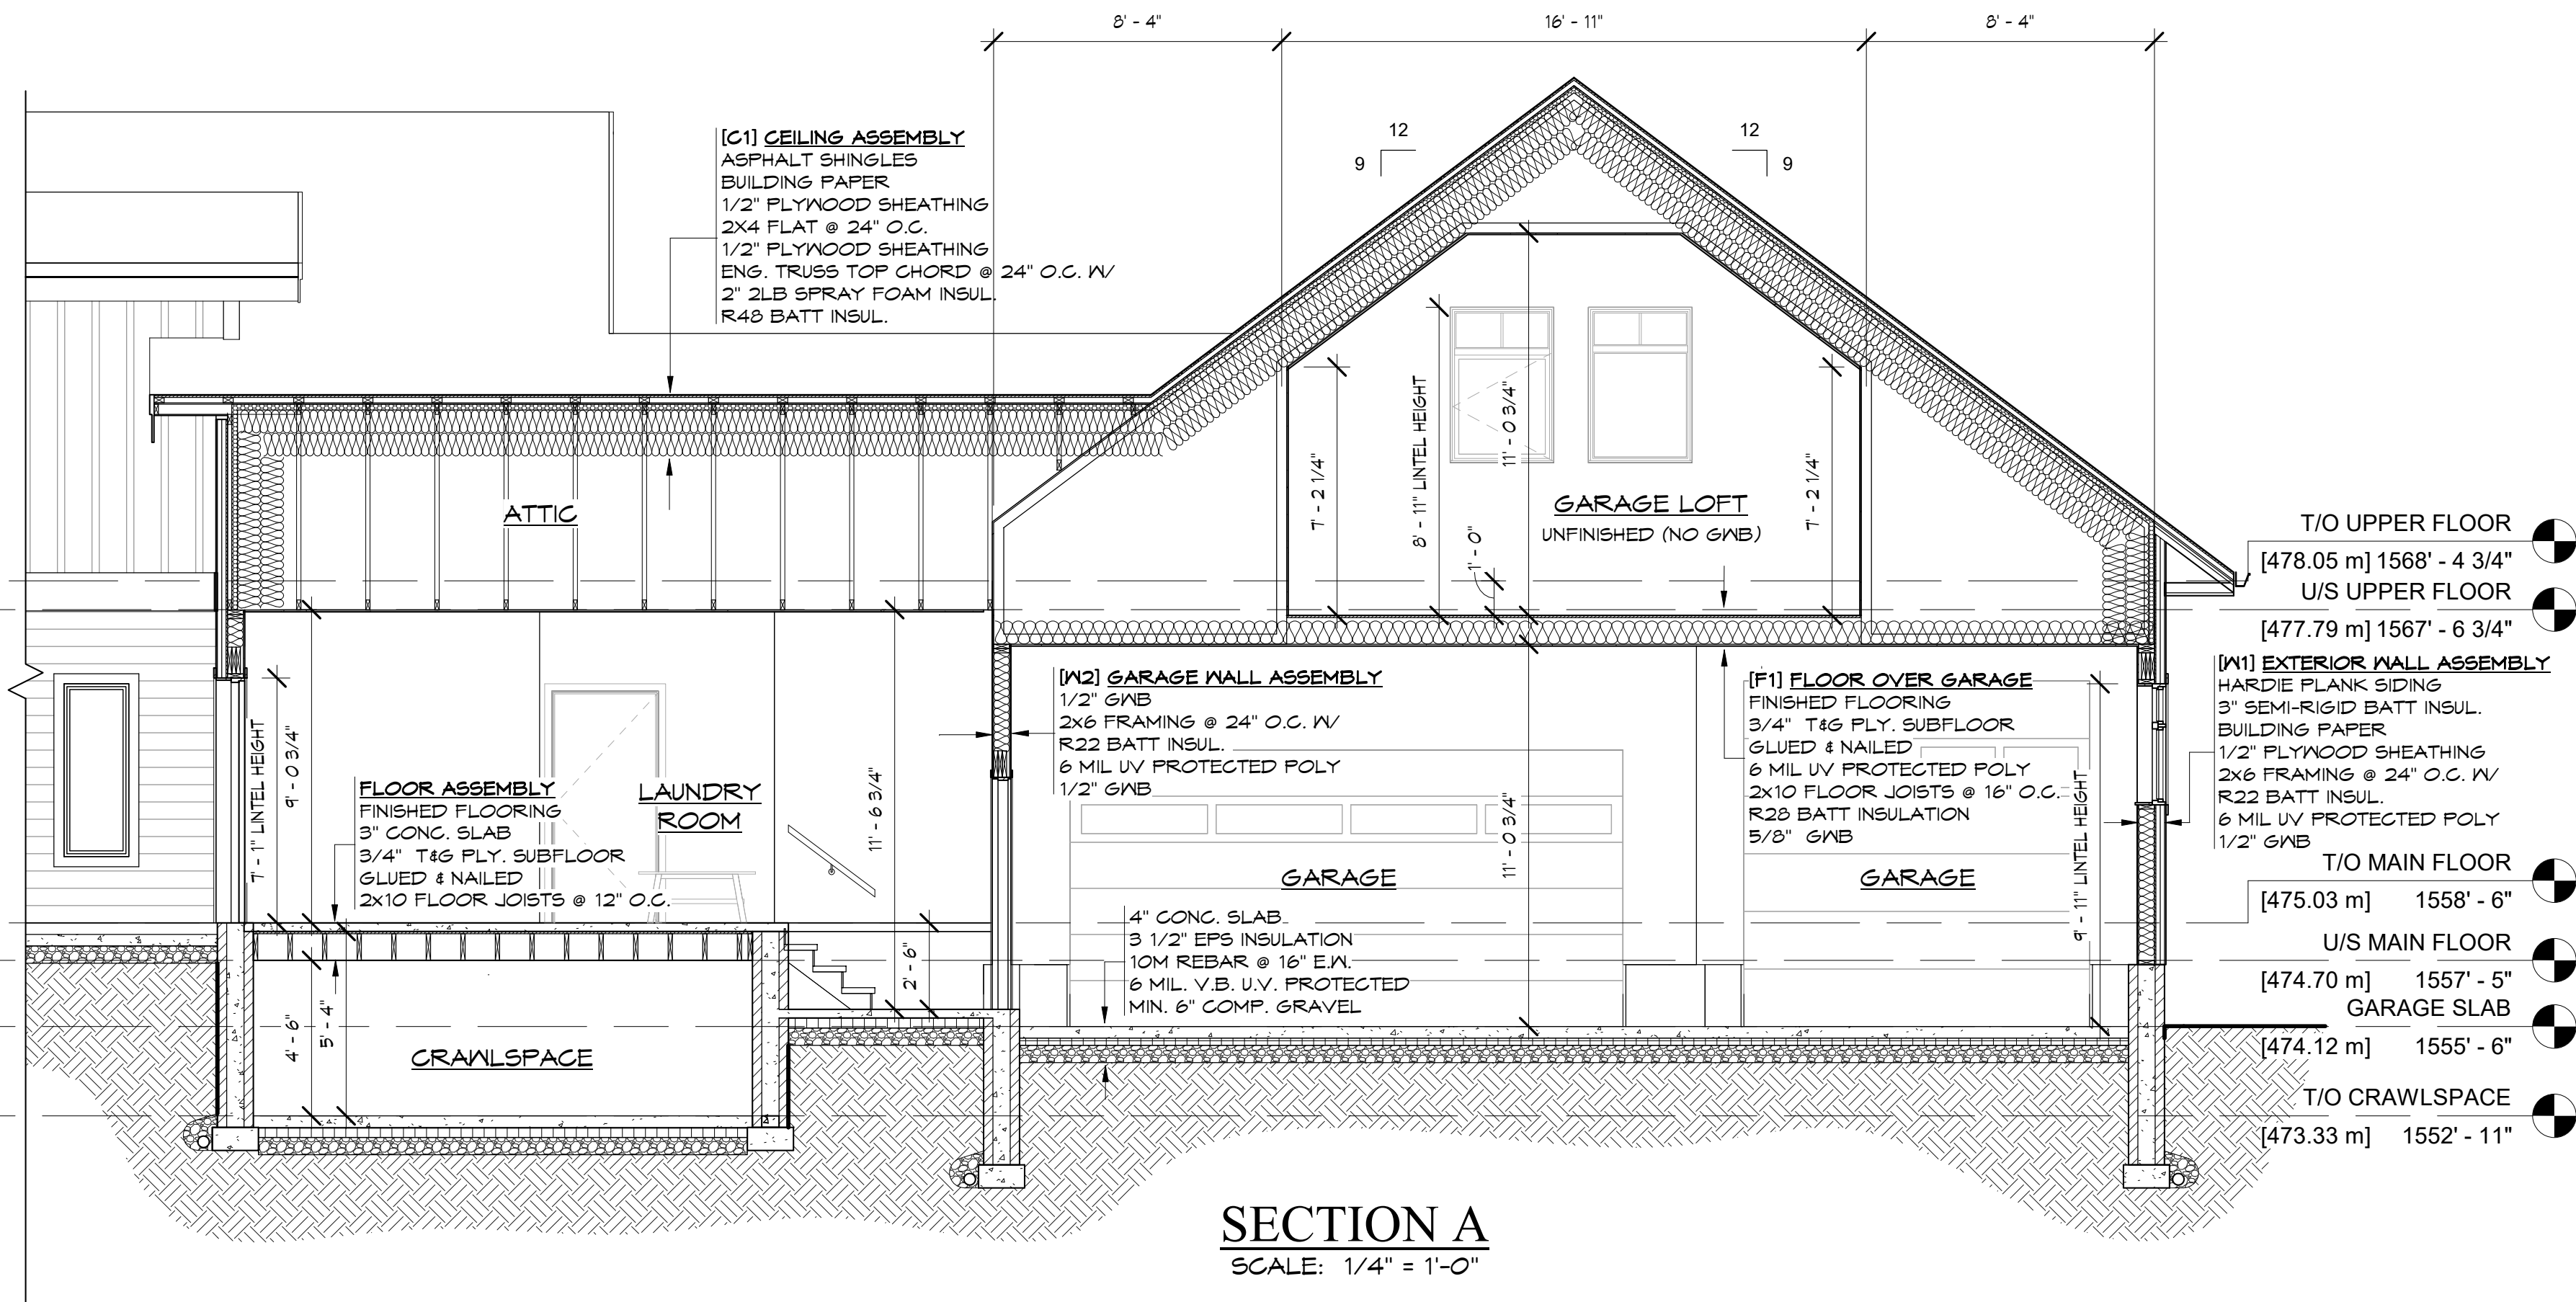


SECTION A  
SCALE: 1/4" = 1'-0"

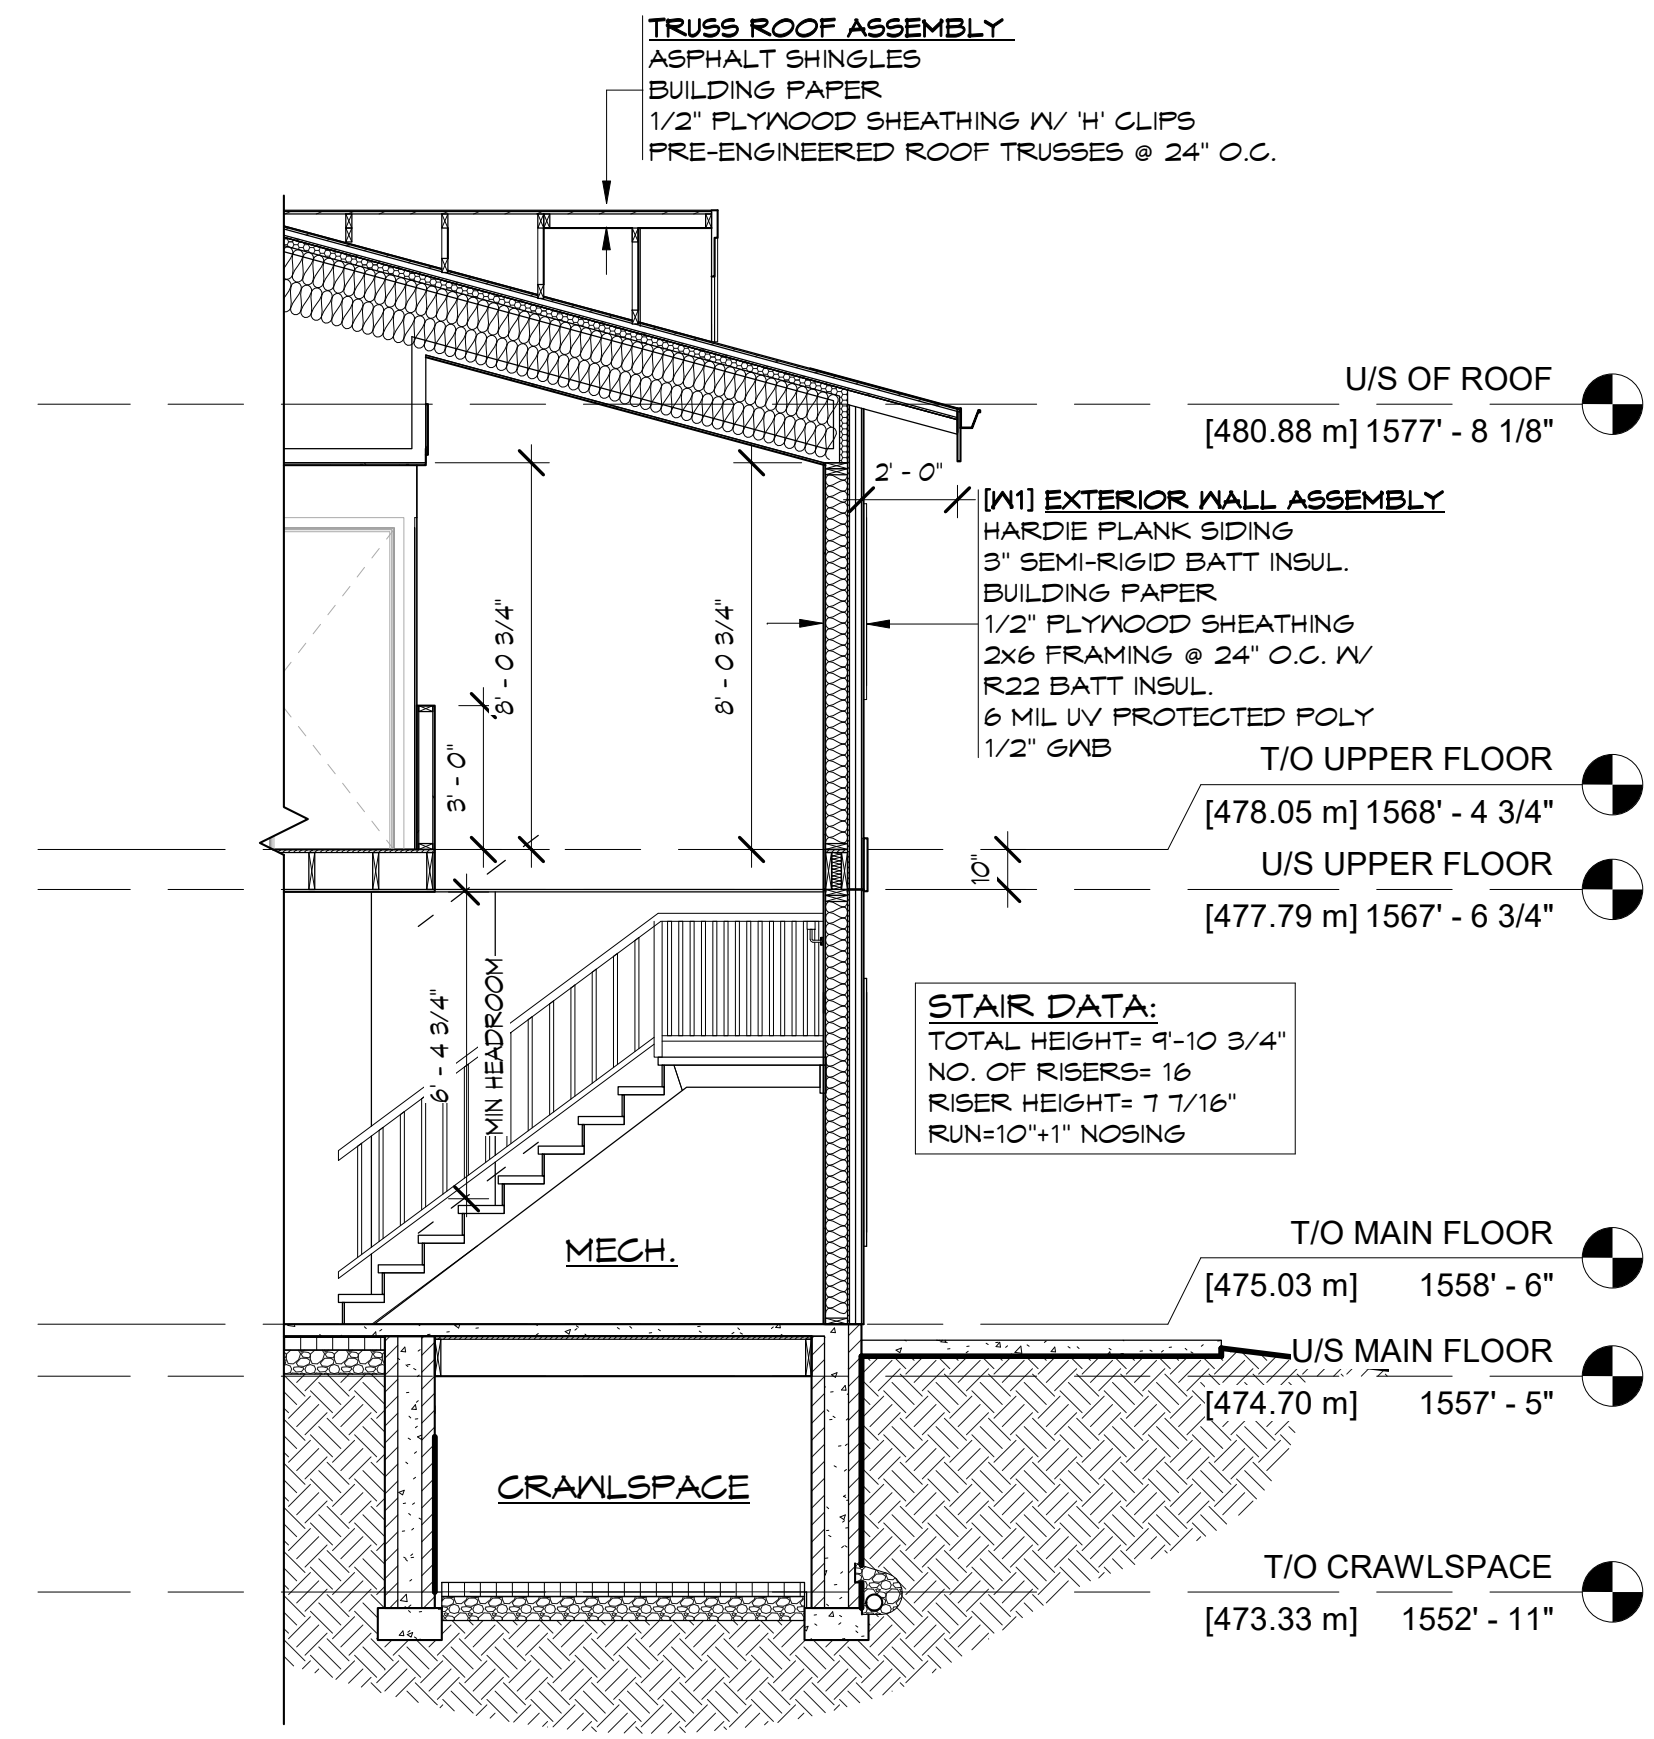

SECTION H  
SCALE: 1/4" = 1'-0"

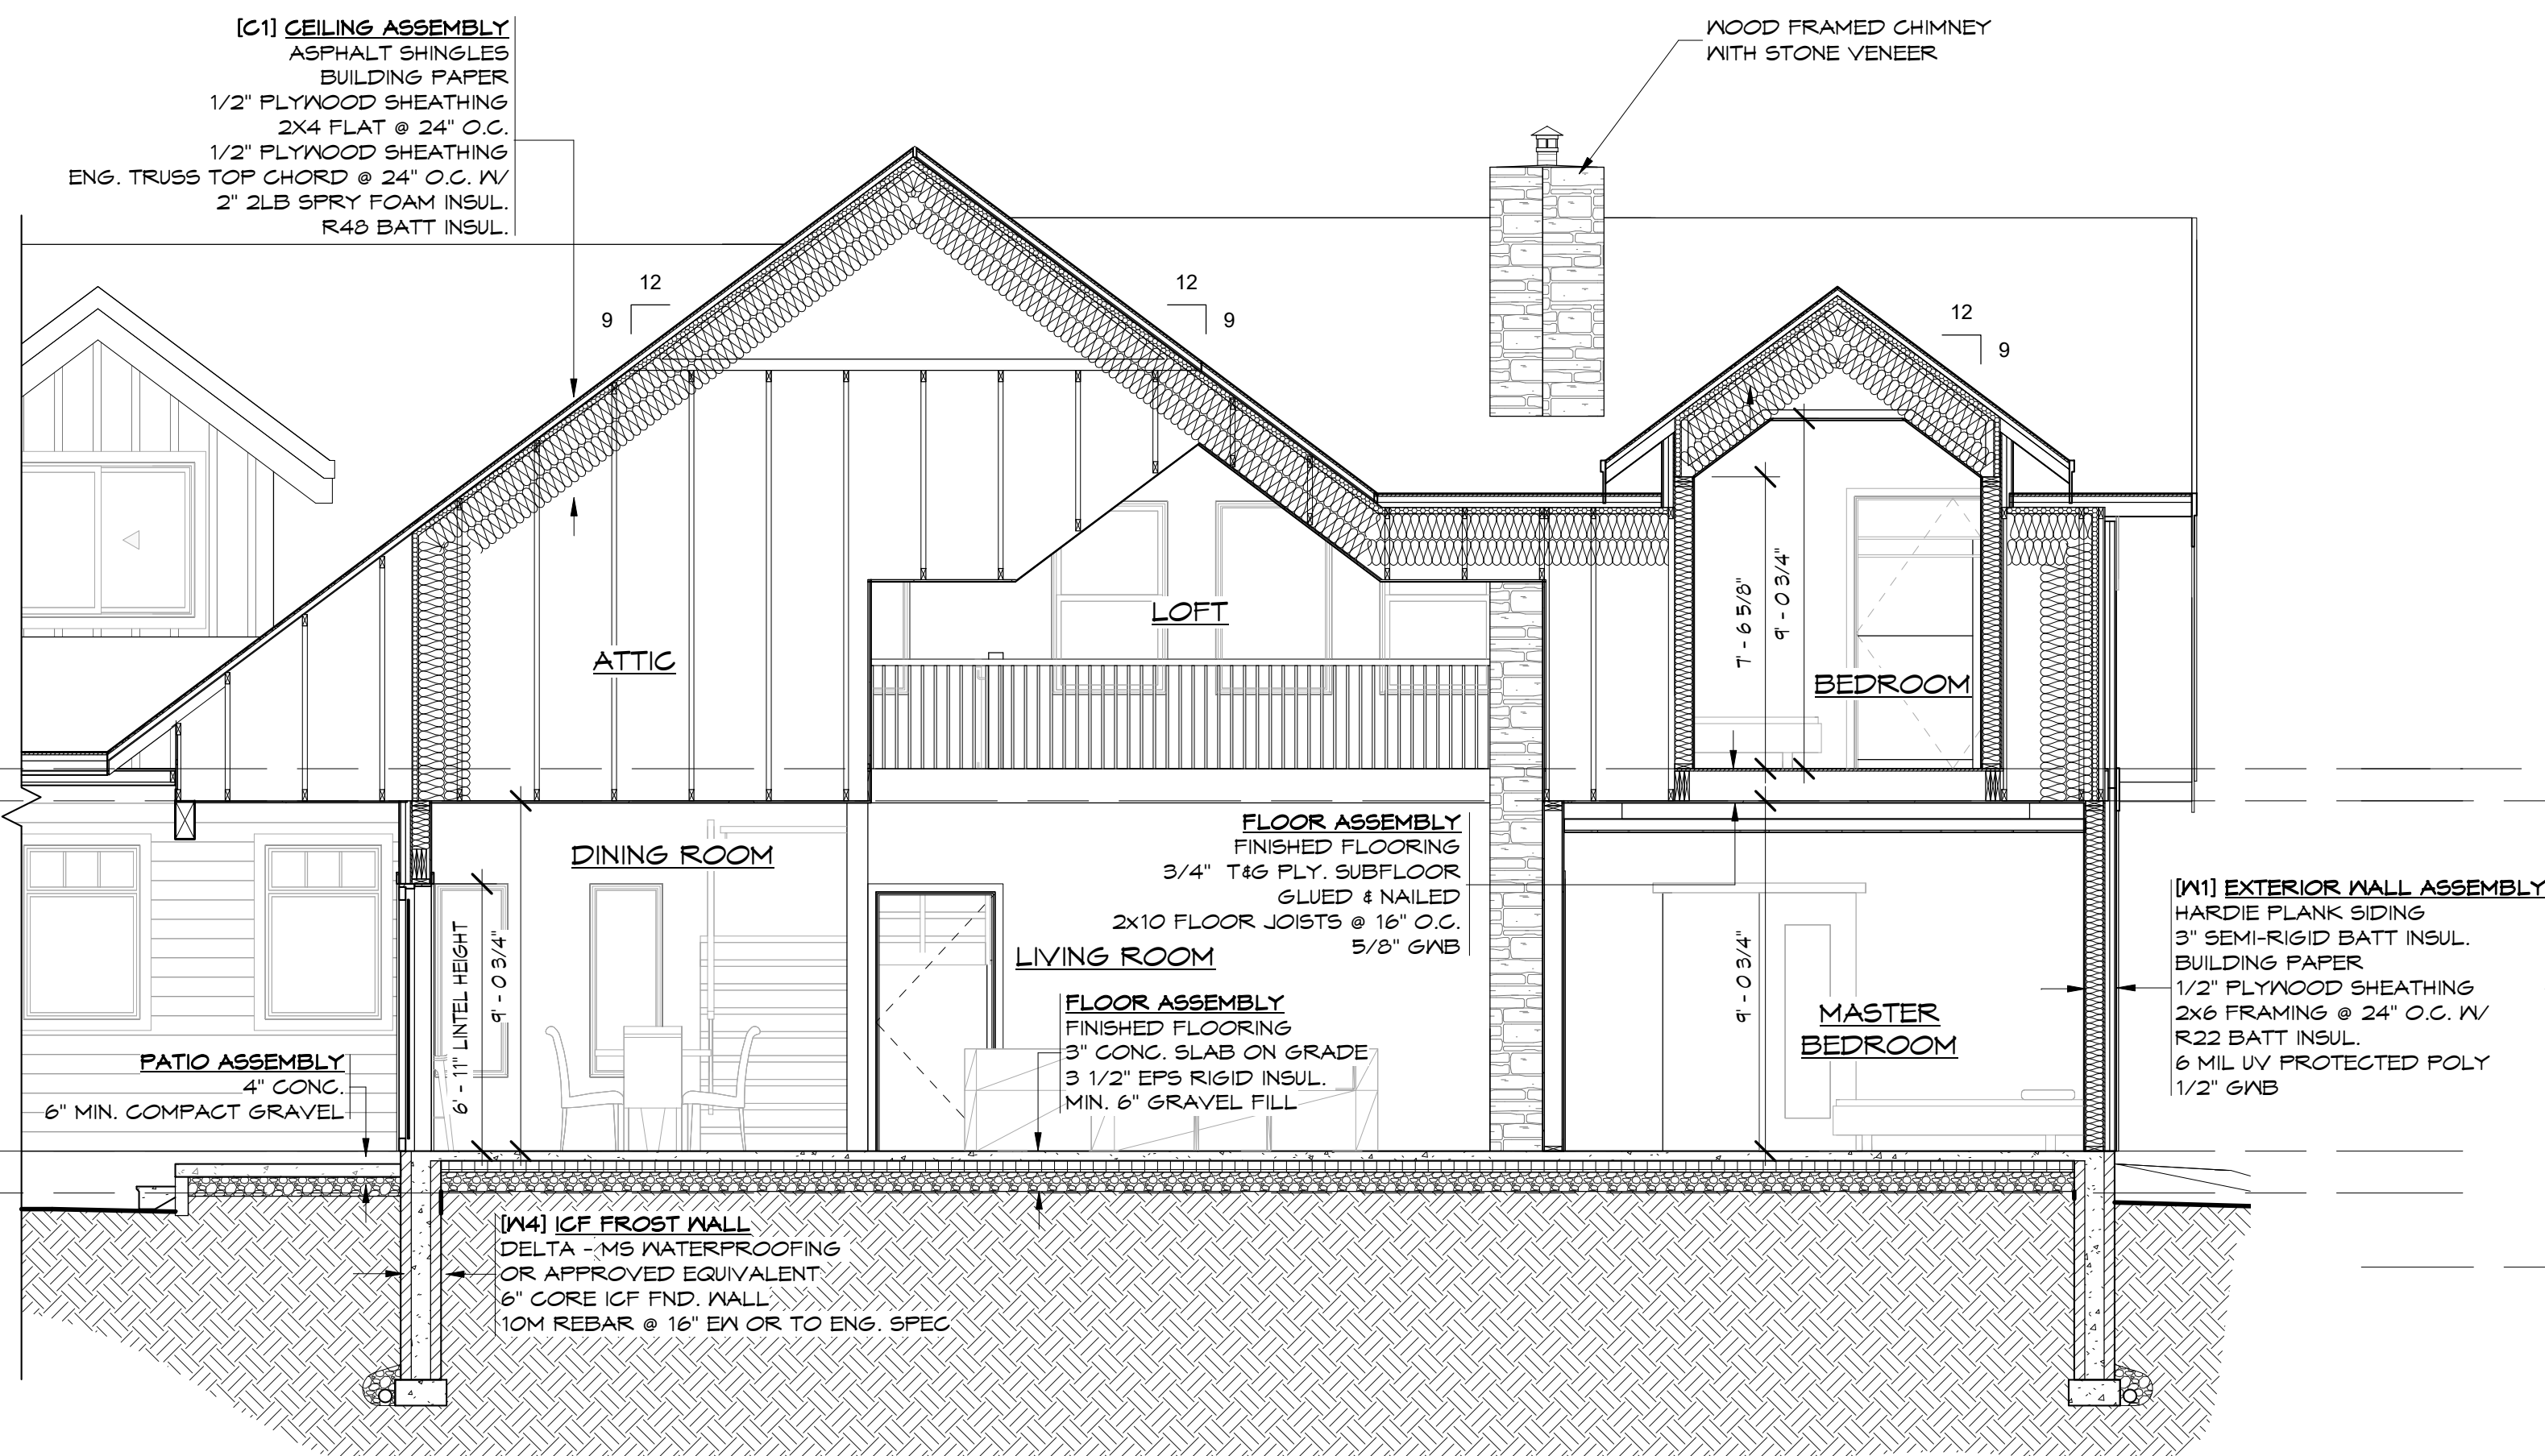

SECTION B  
SCALE: 1/4" = 1'-0"

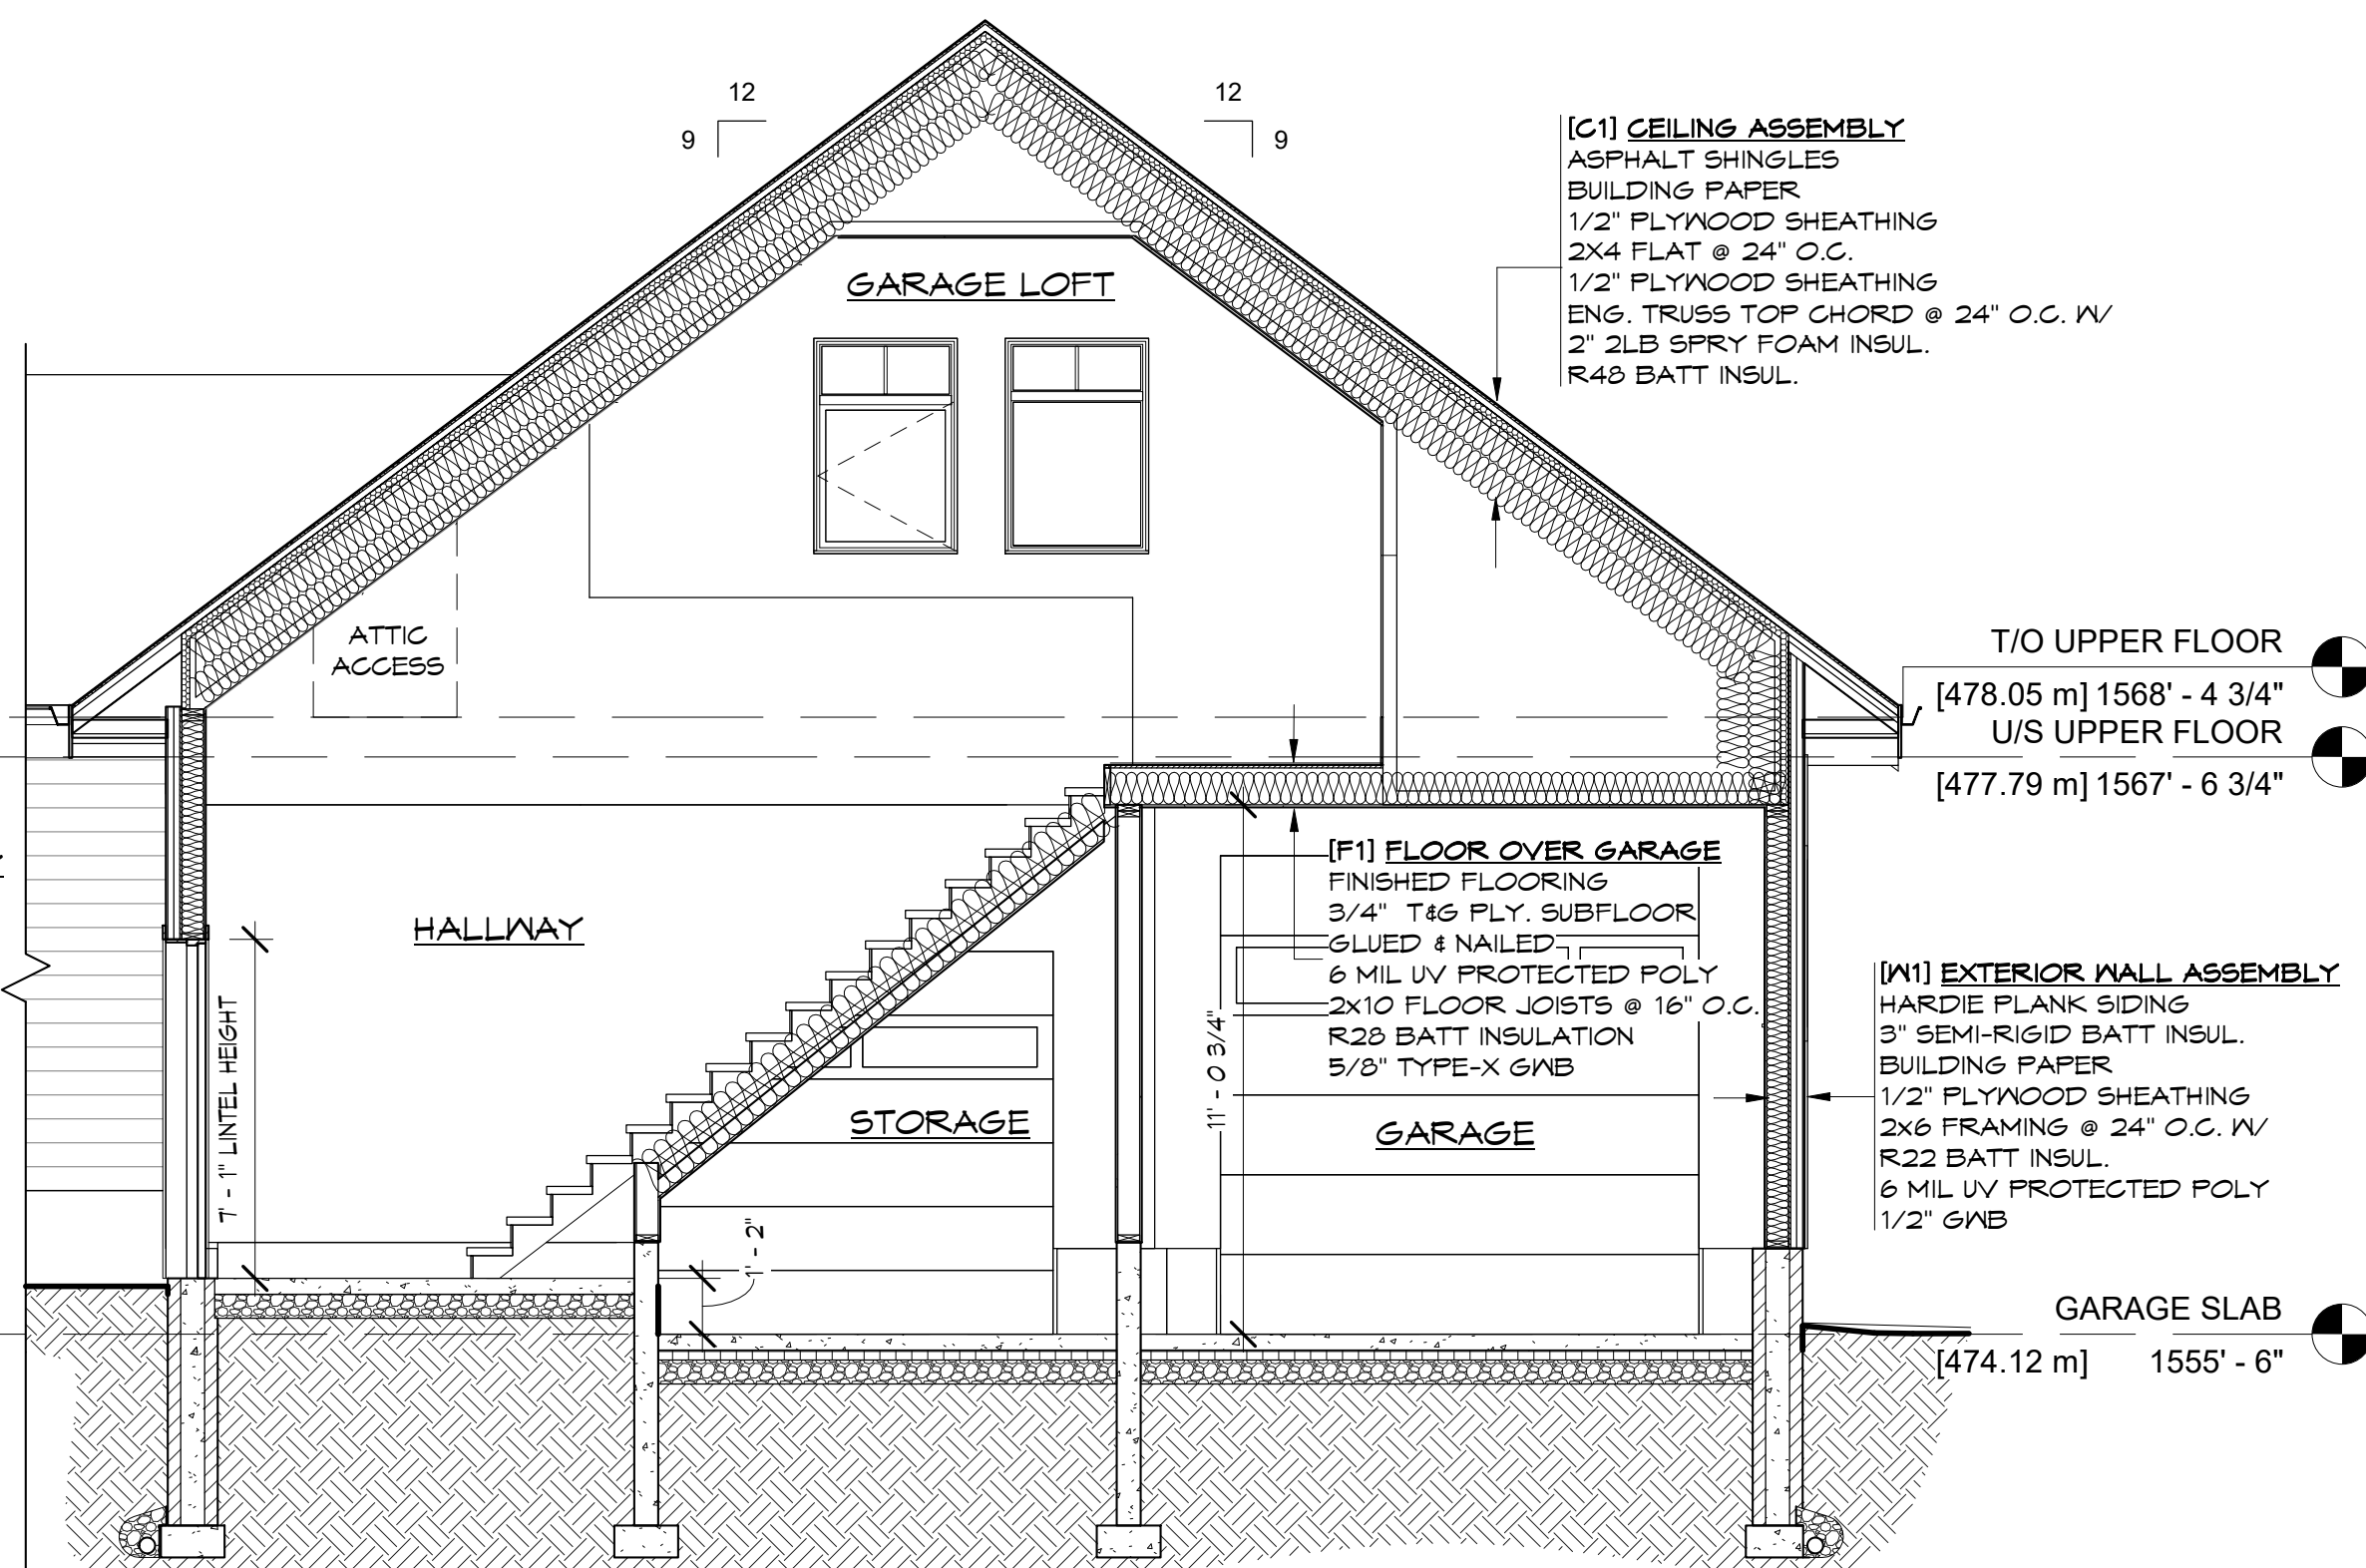

SECTION C  
SCALE: 1/4" = 1'-0"

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A9	PROJECT	ADKINS CUSTOM
	APPROVED	I.W.
S.S.	SCALE	AS NOTED
	DATE	JAN 2021

CLIENT ADKINS, MIKE


TITLE SECTIONS

JOB NUMBER	40K05	A9 OF 12	4
DATE	07/27/21	REV	

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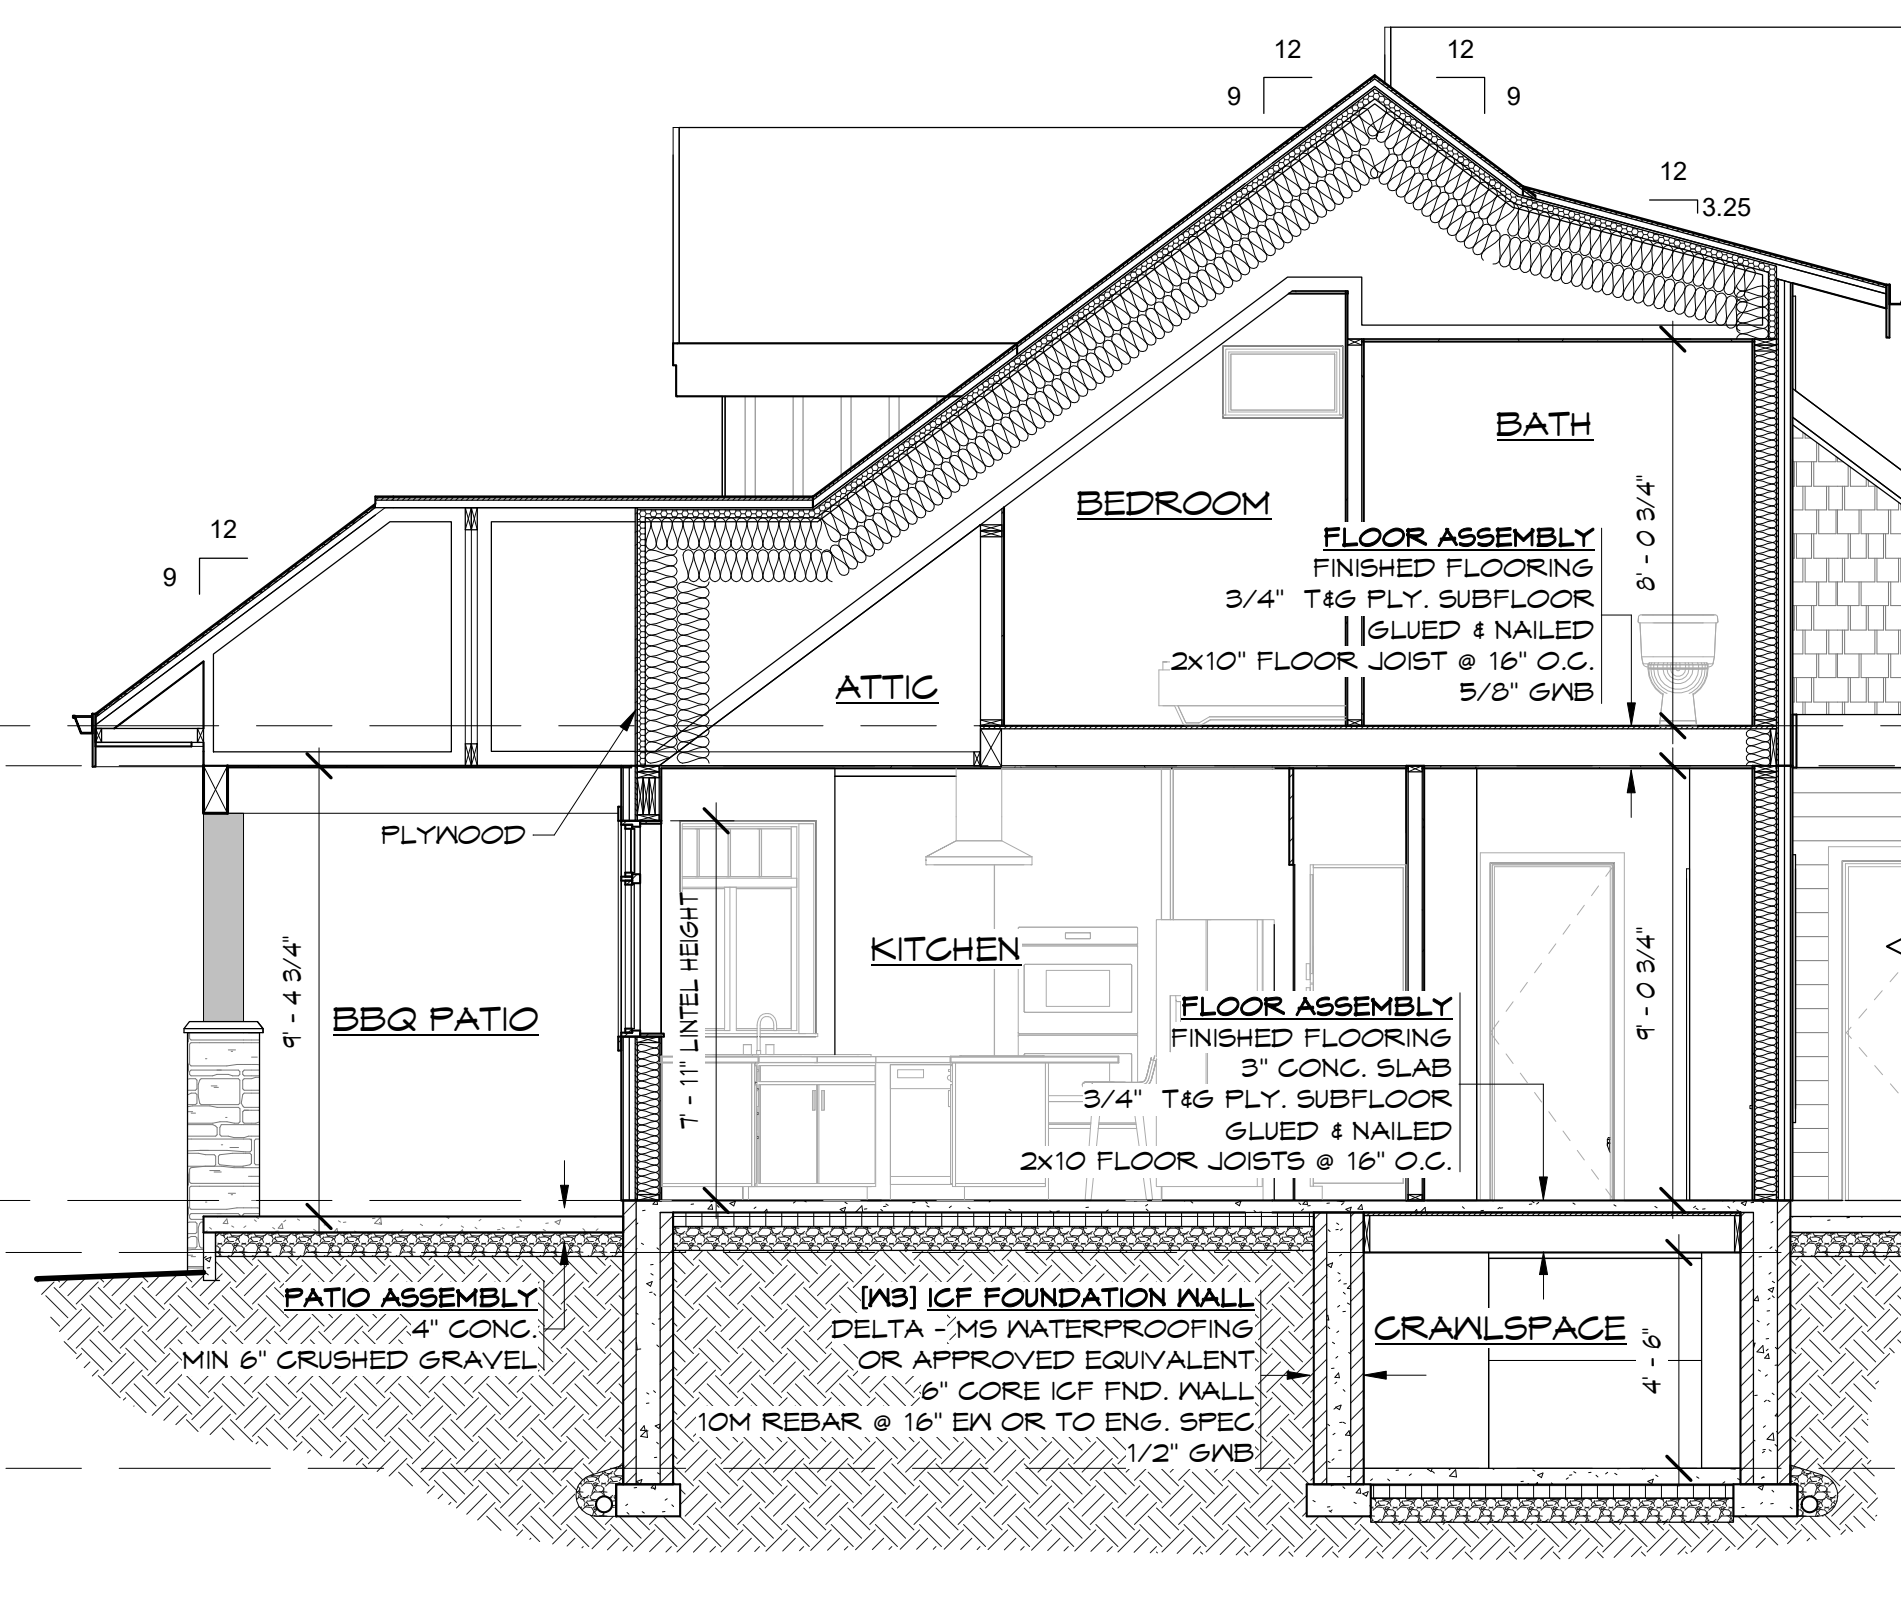
CANCEL ALL PRINTS BEARING EARLIER REVISION



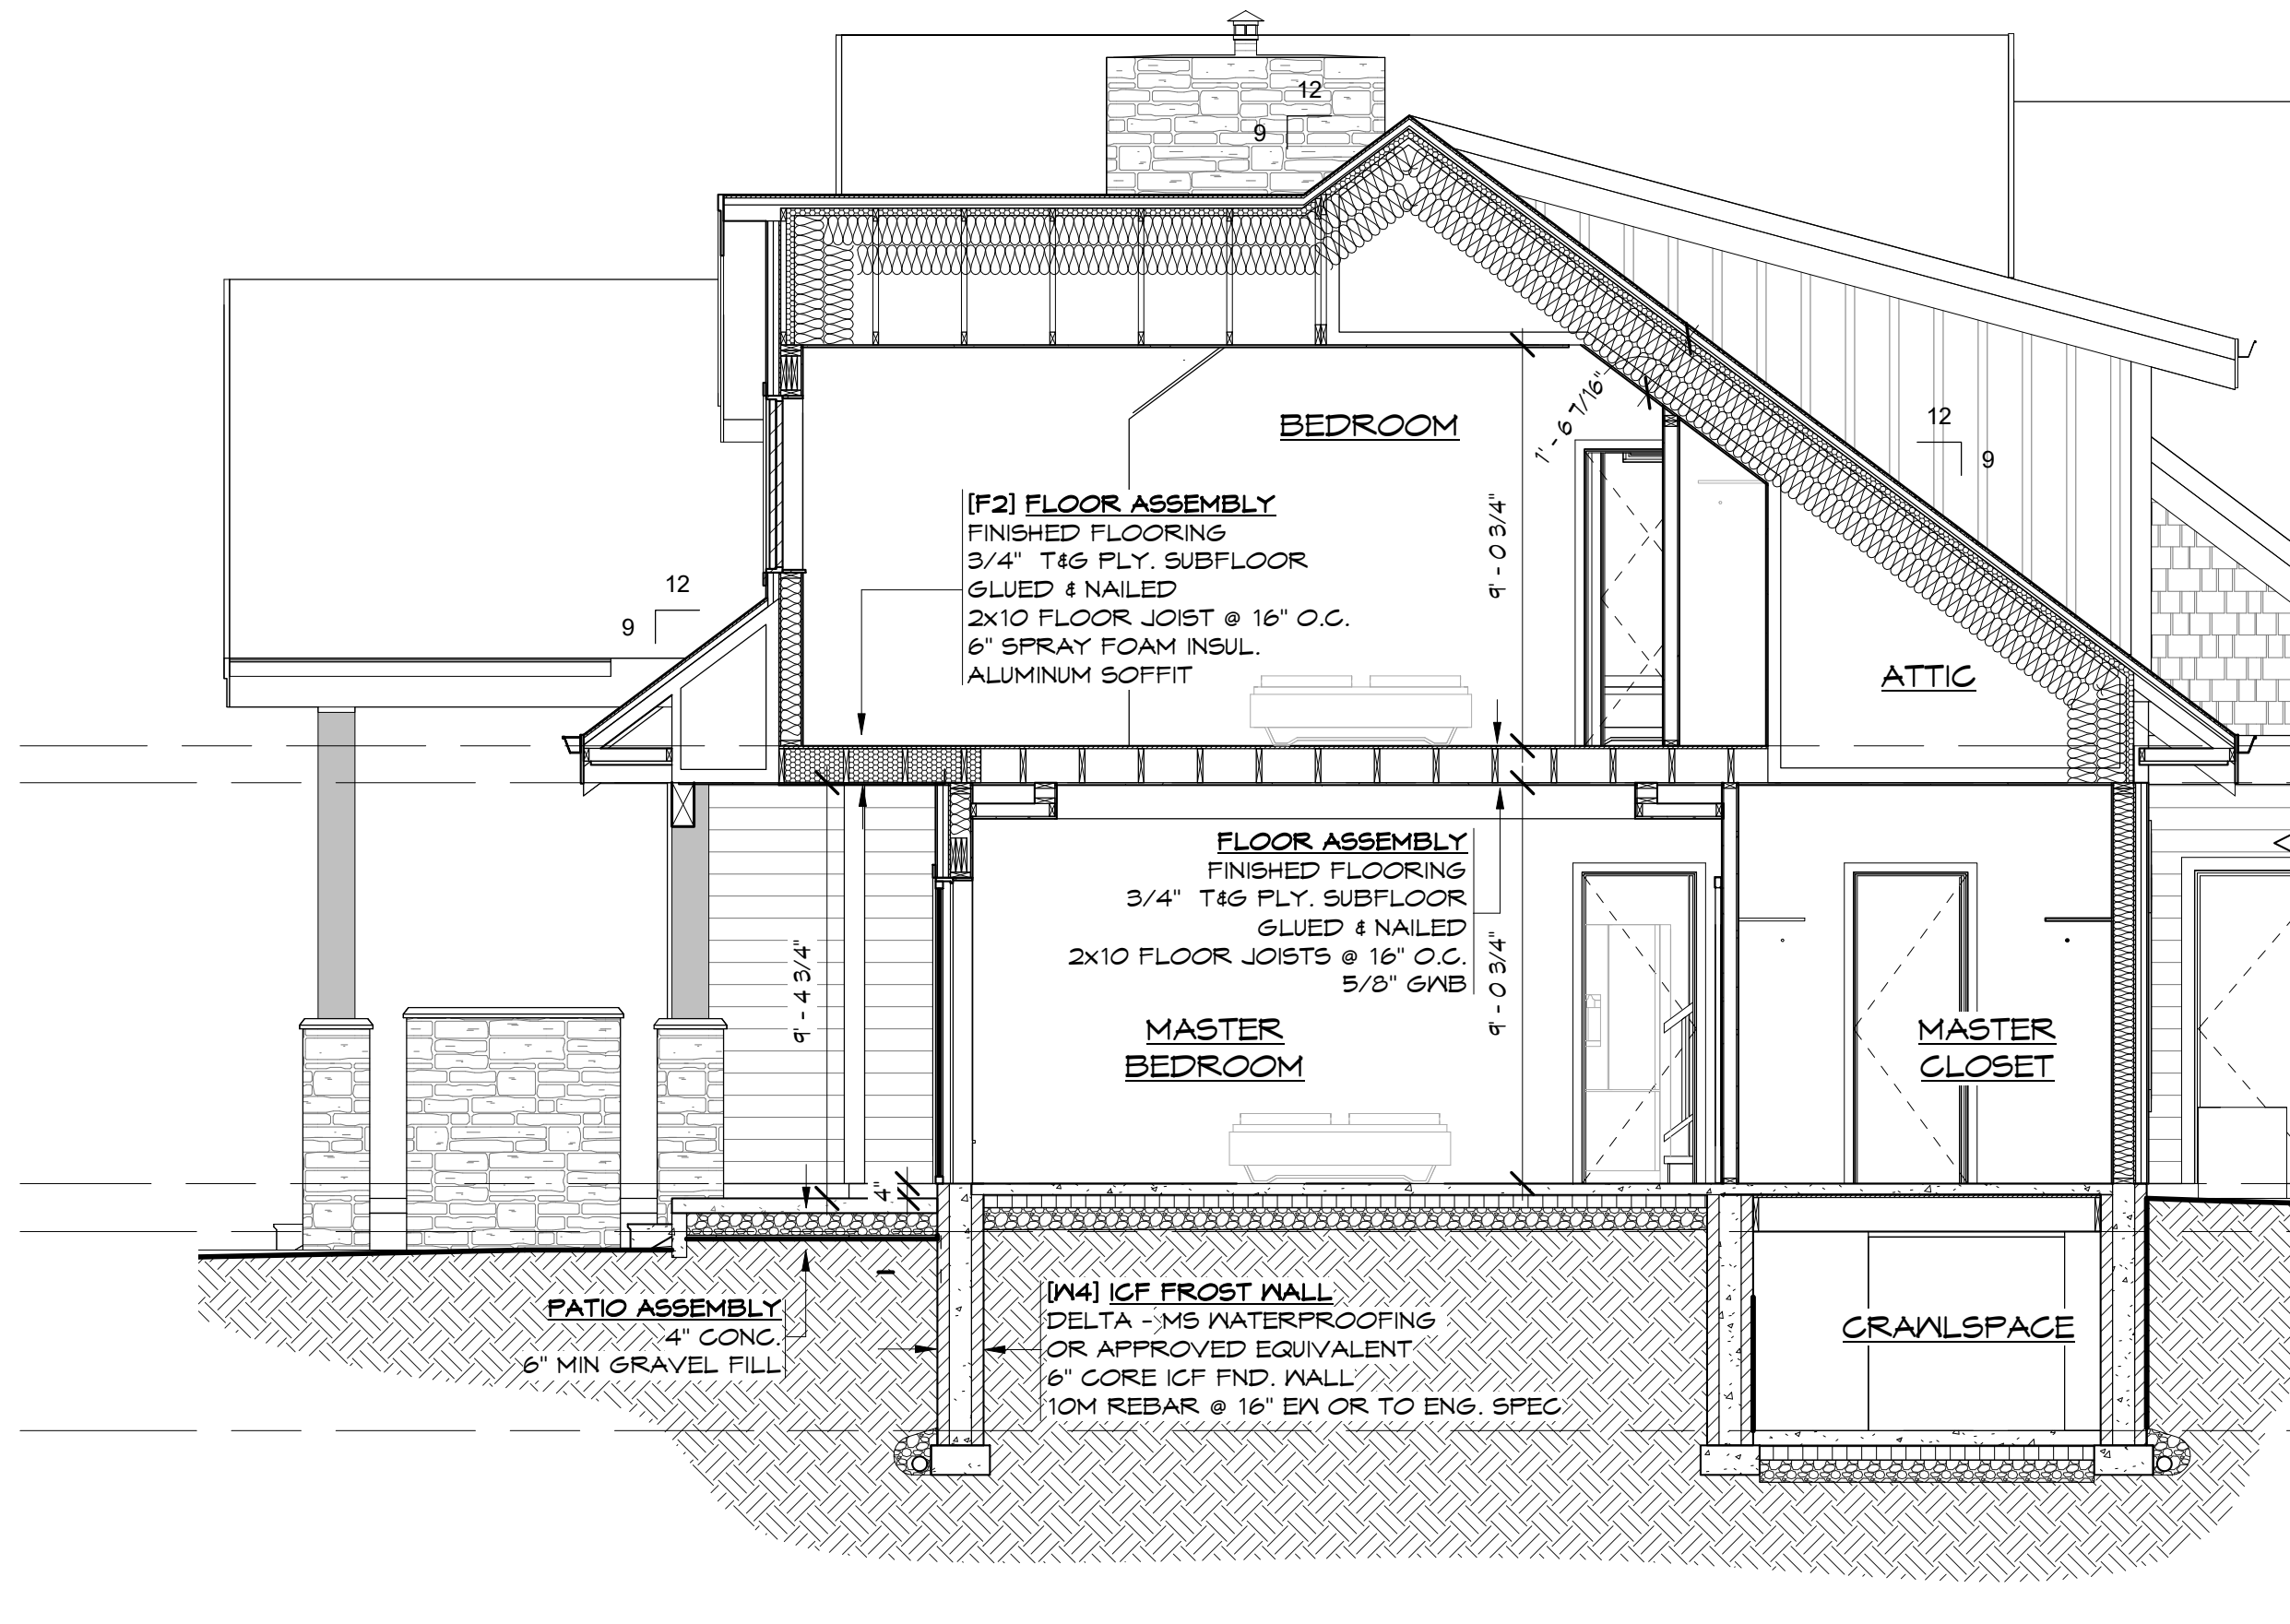


SECTION D  
SCALE: 1/4" = 1'-0"

T/O UPPER FLOOR	●
[478.05 m] 1568' - 4 3/4"	
U/S UPPER FLOOR	●
[477.79 m] 1567' - 6 3/4"	
T/O MAIN FLOOR	●
[475.03 m] 1558' - 6"	
U/S MAIN FLOOR	●
[474.70 m] 1557' - 5"	
T/O CRAWLSPACE	●
[473.33 m] 1552' - 11"	




SECTION E  
SCALE: 1/4" = 1'-0"


T/O UPPER FLOOR	●
[478.05 m] 1568' - 4 3/4"	
U/S UPPER FLOOR	●
[477.79 m] 1567' - 6 3/4"	
T/O MAIN FLOOR	●
[475.03 m] 1558' - 6"	
U/S MAIN FLOOR	●
[474.70 m] 1557' - 5"	
T/O CRAWLSPACE	●
[473.33 m] 1552' - 11"	

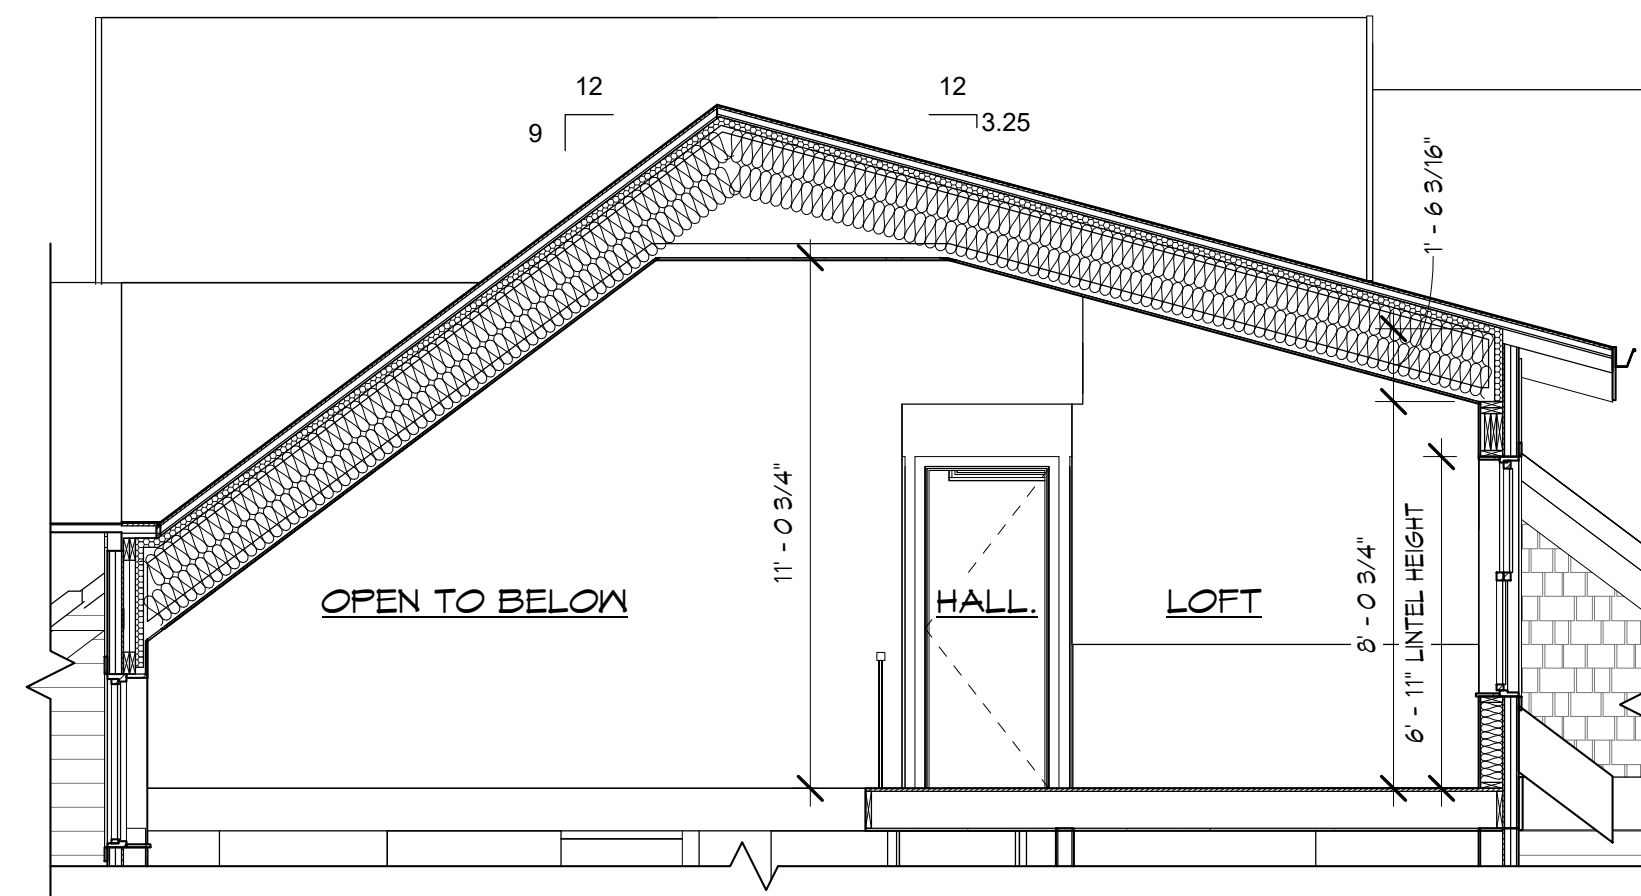

SECTION I  
SCALE: 1/4" = 1'-0"

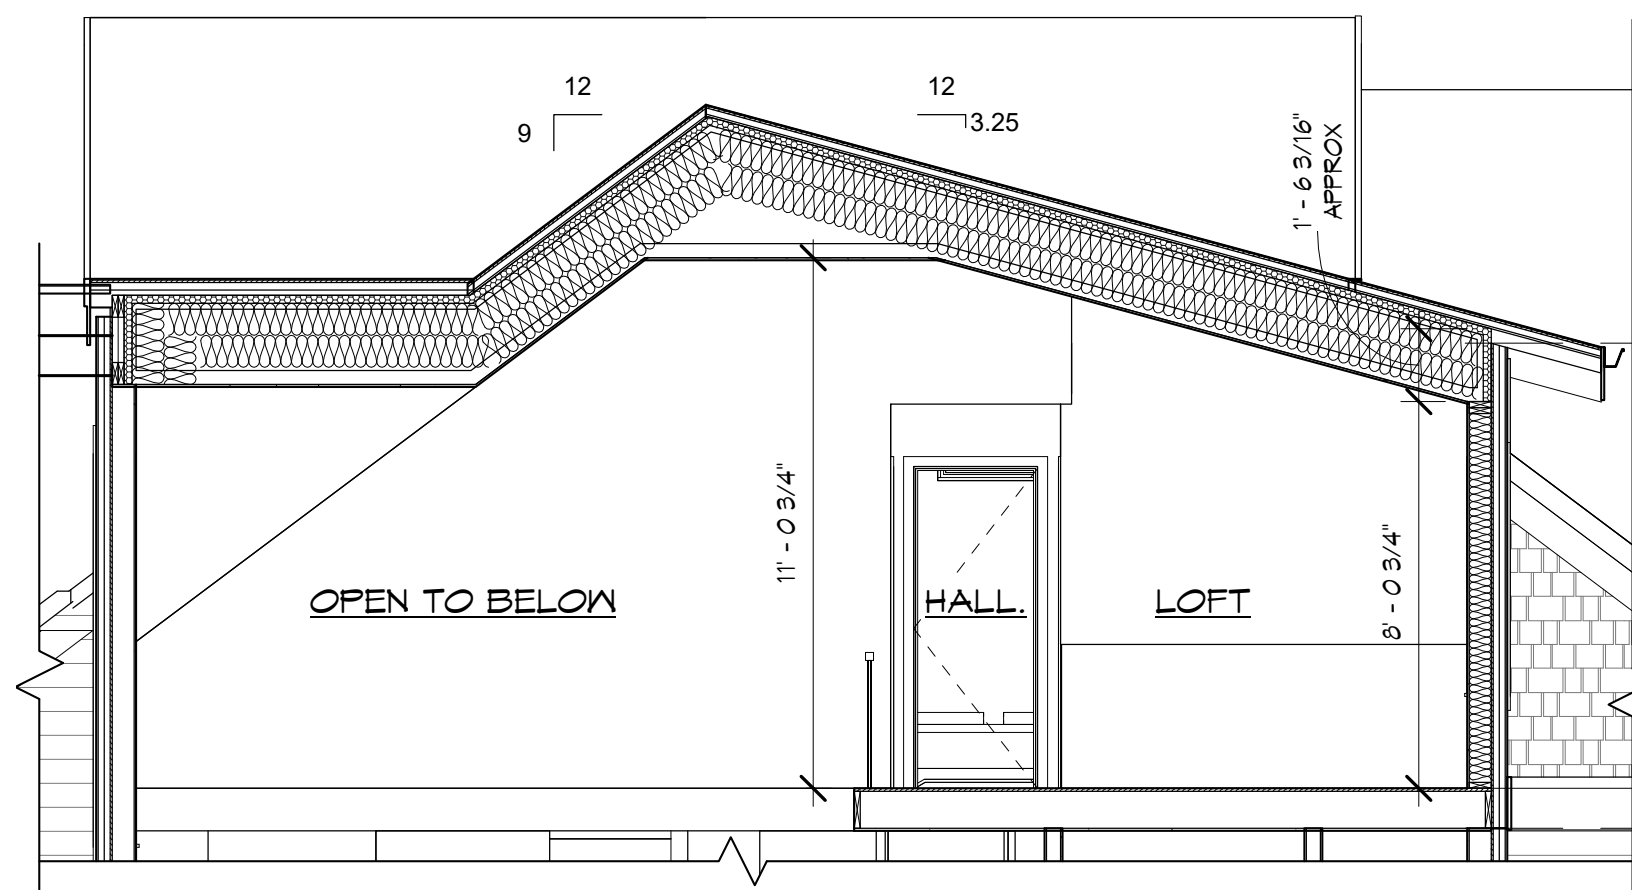

SECTION J  
SCALE: 1/4" = 1'-0"

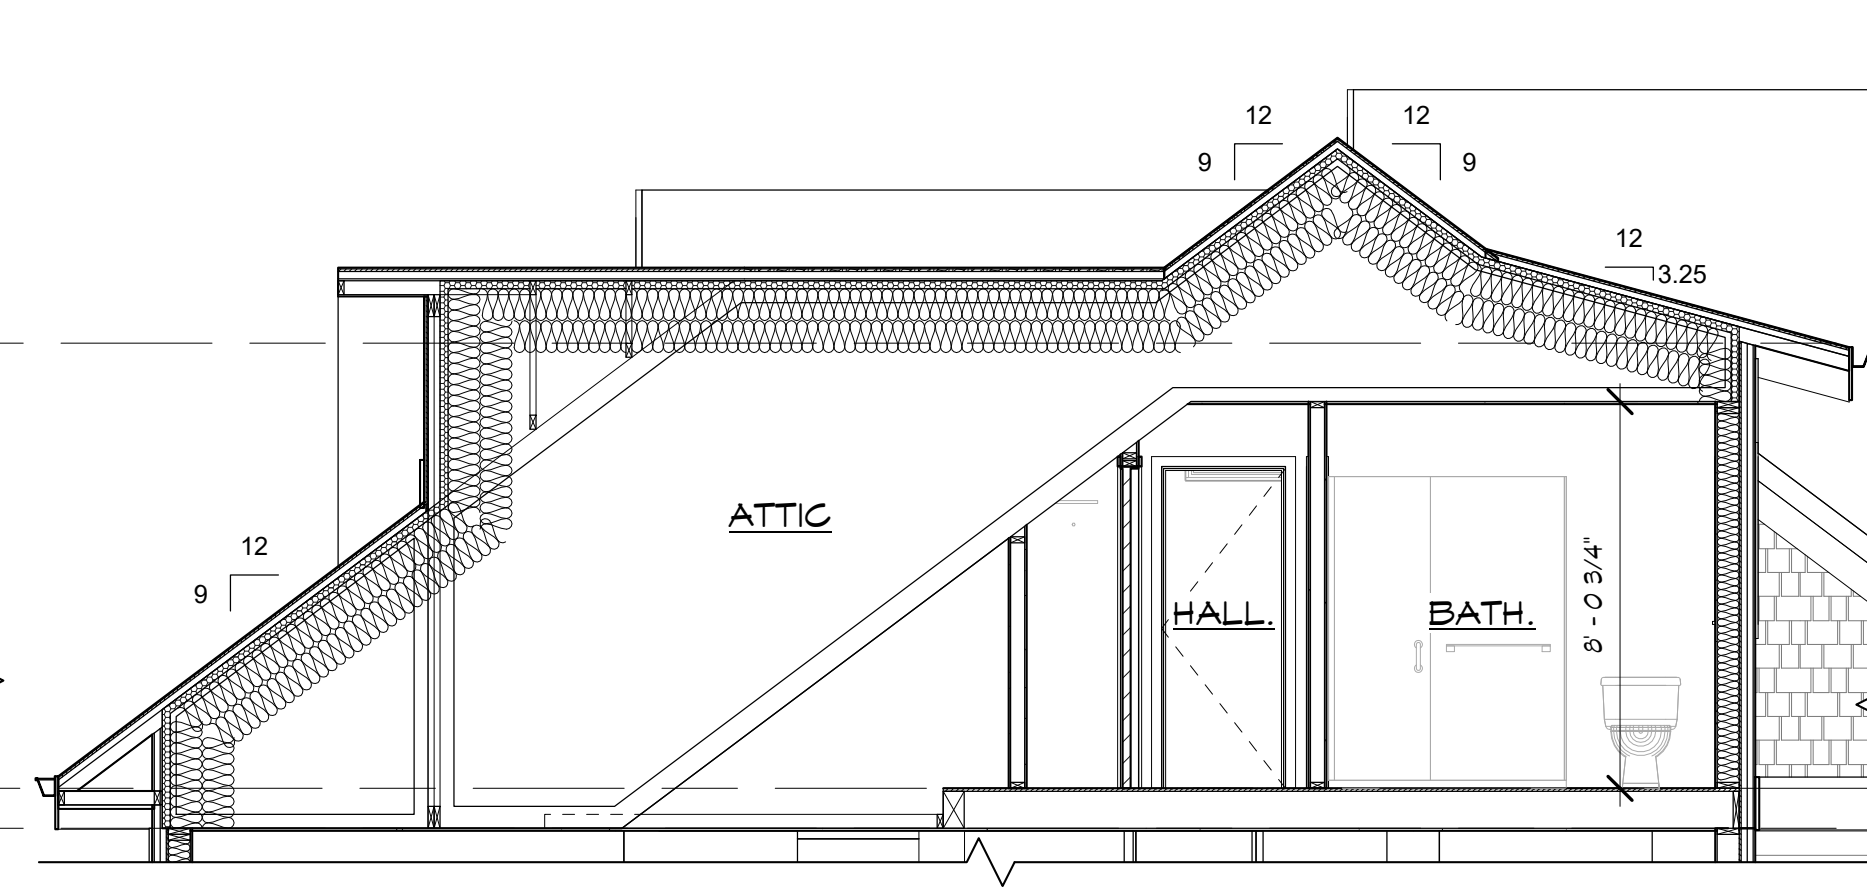

SECTION K  
SCALE: 1/4" = 1'-0"

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EXTERIOR WALL ASSEMBLY (HRV)			
ASSEMBLY TAG	ASSEMBLY DETAIL	EXT. %	INT. %
W1		20 %	20 %
COMPONENT	EFFECTIVE		
EXT. EXTERIOR AIR FILM	0.03 RSI		
HARDIE PLANK SIDING	0.03 RSI		
1 1/2" SEMI-RIGID BATT VV FLAT 2x4	0.94 RSI		
1 1/2" SEMI-RIGID BATT INSUL	1.09 RSI		
BUILDING PAPER	0 RSI		
1/2" PLYWOOD SHEATHING	0.11 RSI		
2x6 STUDS @ 24" O.C.	2.61 RSI		
VV R-22 BATT INSULATION	0 RSI		
6 MIL UV PROTECTED POLY	0.09 RSI		
1/2" GNB	0.12 RSI		
INTERIOR AIR FILM - WALL	0 RSI		
INT.			
TOTAL EFFECTIVE =		5.09 RSI	
MINIMUM (HRV) =		2.91 RSI	

GARAGE/ DWELLING WALL ASSEMBLY (HRV)			
ASSEMBLY TAG	ASSEMBLY DETAIL	NT. %	INT. %
W2		20 %	20 %
COMPONENT	EFFECTIVE		
NT. -	0 RSI		
-	0 RSI		
-	0 RSI		
INTERIOR AIR FILM - WALL	0.12 RSI		
1/2" GNB	0.08 RSI		
6 MIL UV PROTECTED V.B.	0 RSI		
2x6 STUDS @ 24" O.C.	2.61 RSI		
VV R-22 BATT INSULATION	0 RSI		
1/2" GNB	0.09 RSI		
EXTERIOR AIR FILM	0.03 RSI		
EXT.	0 RSI		
TOTAL EFFECTIVE =		2.98 RSI	
MINIMUM (HRV) =		2.81 RSI	

ICF FOUNDATION WALL (HRV / NO HRV)			
ASSEMBLY TAG	ASSEMBLY DETAIL	EXT. %	INT. %
W3		20 %	20 %
COMPONENT	EFFECTIVE		
EXT. -	0 RSI		
-	0 RSI		
-	0 RSI		
WATERPROOF MEMBRANE	0.03 RSI		
3-1/4" EPS FOAM	2.31 RSI		
6" CONCRETE CORE	0.06 RSI		
3-1/4" EPS FOAM	2.31 RSI		
1/2" GNB	0.09 RSI		
INTERIOR AIR FILM - WALL	0.12 RSI		
-	0 RSI		
-	0 RSI		
INT.	0 RSI		
TOTAL EFFECTIVE =		4.91 RSI	
MINIMUM (HRV / NO HRV) =		2.98 RSI	

ICF FOUNDATION FROST WALL (HRV / NO HRV)			
ASSEMBLY TAG	ASSEMBLY DETAIL	EXT. %	INT. %
W4		20 %	20 %
COMPONENT	EFFECTIVE		
EXT. -	0 RSI		
-	0 RSI		
-	0 RSI		
WATERPROOF MEMBRANE	0.03 RSI		
3-1/4" EPS FOAM	2.31 RSI		
6" CONCRETE CORE	0.06 RSI		
3-1/4" EPS FOAM	2.31 RSI		
-	0 RSI		
-	0 RSI		
-	0 RSI		
INT.	0 RSI		
TOTAL EFFECTIVE =		4.71 RSI	
MINIMUM (HRV / NO HRV) =		2.98 RSI	

FLOOR OVER GARAGE (HRV / NO HRV)			
ASSEMBLY TAG	ASSEMBLY DETAIL	NT. %	EXT. %
F1		13 %	20 %
COMPONENT	EFFECTIVE		
NT. -	0 RSI		
-	0 RSI		
-	0 RSI		
INTERIOR AIR FILM - FLOOR	0.16 RSI		
FLOORING - HARDWOOD	0.12 RSI		
3/4" PLYWOOD SUBFLOOR	0.16 RSI		
2X10 FLOOR JOISTS @ 16" O.C.	4.14 RSI		
VV R-22 BATT INSULATION	0 RSI		
6 MIL UV PROTECTED POLY	0 RSI		
5/8" GNB	0.1 RSI		
EXTERIOR AIR FILM	0.03 RSI		
EXT.	0 RSI		
TOTAL EFFECTIVE =		4.71 RSI	
MINIMUM (HRV / NO HRV) =		4.51 RSI	

FLOOR OVER EXTERIOR (WITH HRV)			
ASSEMBLY TAG	ASSEMBLY DETAIL	NT. %	EXT. %
F2		13 %	20 %
COMPONENT	EFFECTIVE		
NT. -	0 RSI		
-	0 RSI		
-	0 RSI		
INTERIOR AIR FILM - FLOOR	0.16 RSI		
FLOORING - HARDWOOD	0.12 RSI		
3/4" PLYWOOD SUBFLOOR	0.16 RSI		
2X10 FLOOR JOISTS @ 16" O.C.	4.41 RSI		
VV 2" OF 2 LB SPRAY FOAM	0 RSI		
METAL SOFFIT	0 RSI		
EXTERIOR AIR FILM	0.03 RSI		
EXT.	0 RSI		
TOTAL EFFECTIVE =		4.94 RSI	
MINIMUM (WITH HRV) =		4.67 RSI	

CEILING ASSEMBLY (WITH HRV)			
ASSEMBLY TAG	ASSEMBLY DETAIL	EXT. %	INT. %
C1		10 %	20 %
COMPONENT	EFFECTIVE		
EXT. EXTERIOR AIR FILM	0.03 RSI		
ASPHALT SHINGLE	0.08 RSI		
BUILDING PAPER	0 RSI		
1/2" PLYWOOD SHEATHING	0.11 RSI		
1-1/2" AIRSPACE	0.03 RSI		
1/2" PLYWOOD SHEATHING	0.11 RSI		
2X4 BOTTOM CHORD @ 24" O.C.	1.58 RSI		
VV 2" OF 2 LB SPRAY FOAM	0.49 RSI		
R48 BATT INSULATION	0.11 RSI		
INTERIOR AIR FILM - CEILING	0 RSI		
INT.	0 RSI		
TOTAL EFFECTIVE =		10.54 RSI	
MINIMUM (WITH HRV) =		6.91 RSI	



#101-1402 McGill Road, Kamloops, BC  
V2C 1L3; 250-828-0321

**A10**  
DRAWN: S.S.  
FILE: S.S.  
PROJECT: ADKINS CUSTOM  
APPROVED: I.W.  
SCALE: AS NOTED  
DATE: JAN 2021

CLIENT: ADKINS, MIKE


TITLE: SECTIONS & THERMAL CALCS

JOB NUMBER: 40K05  
A10 OF 12  
DYES NO: 5  
REV: 5

REVISED 07/27/21  
MONTH DAY YEAR

CANCEL ALL PRINTS BEARING EARLIER REVISION



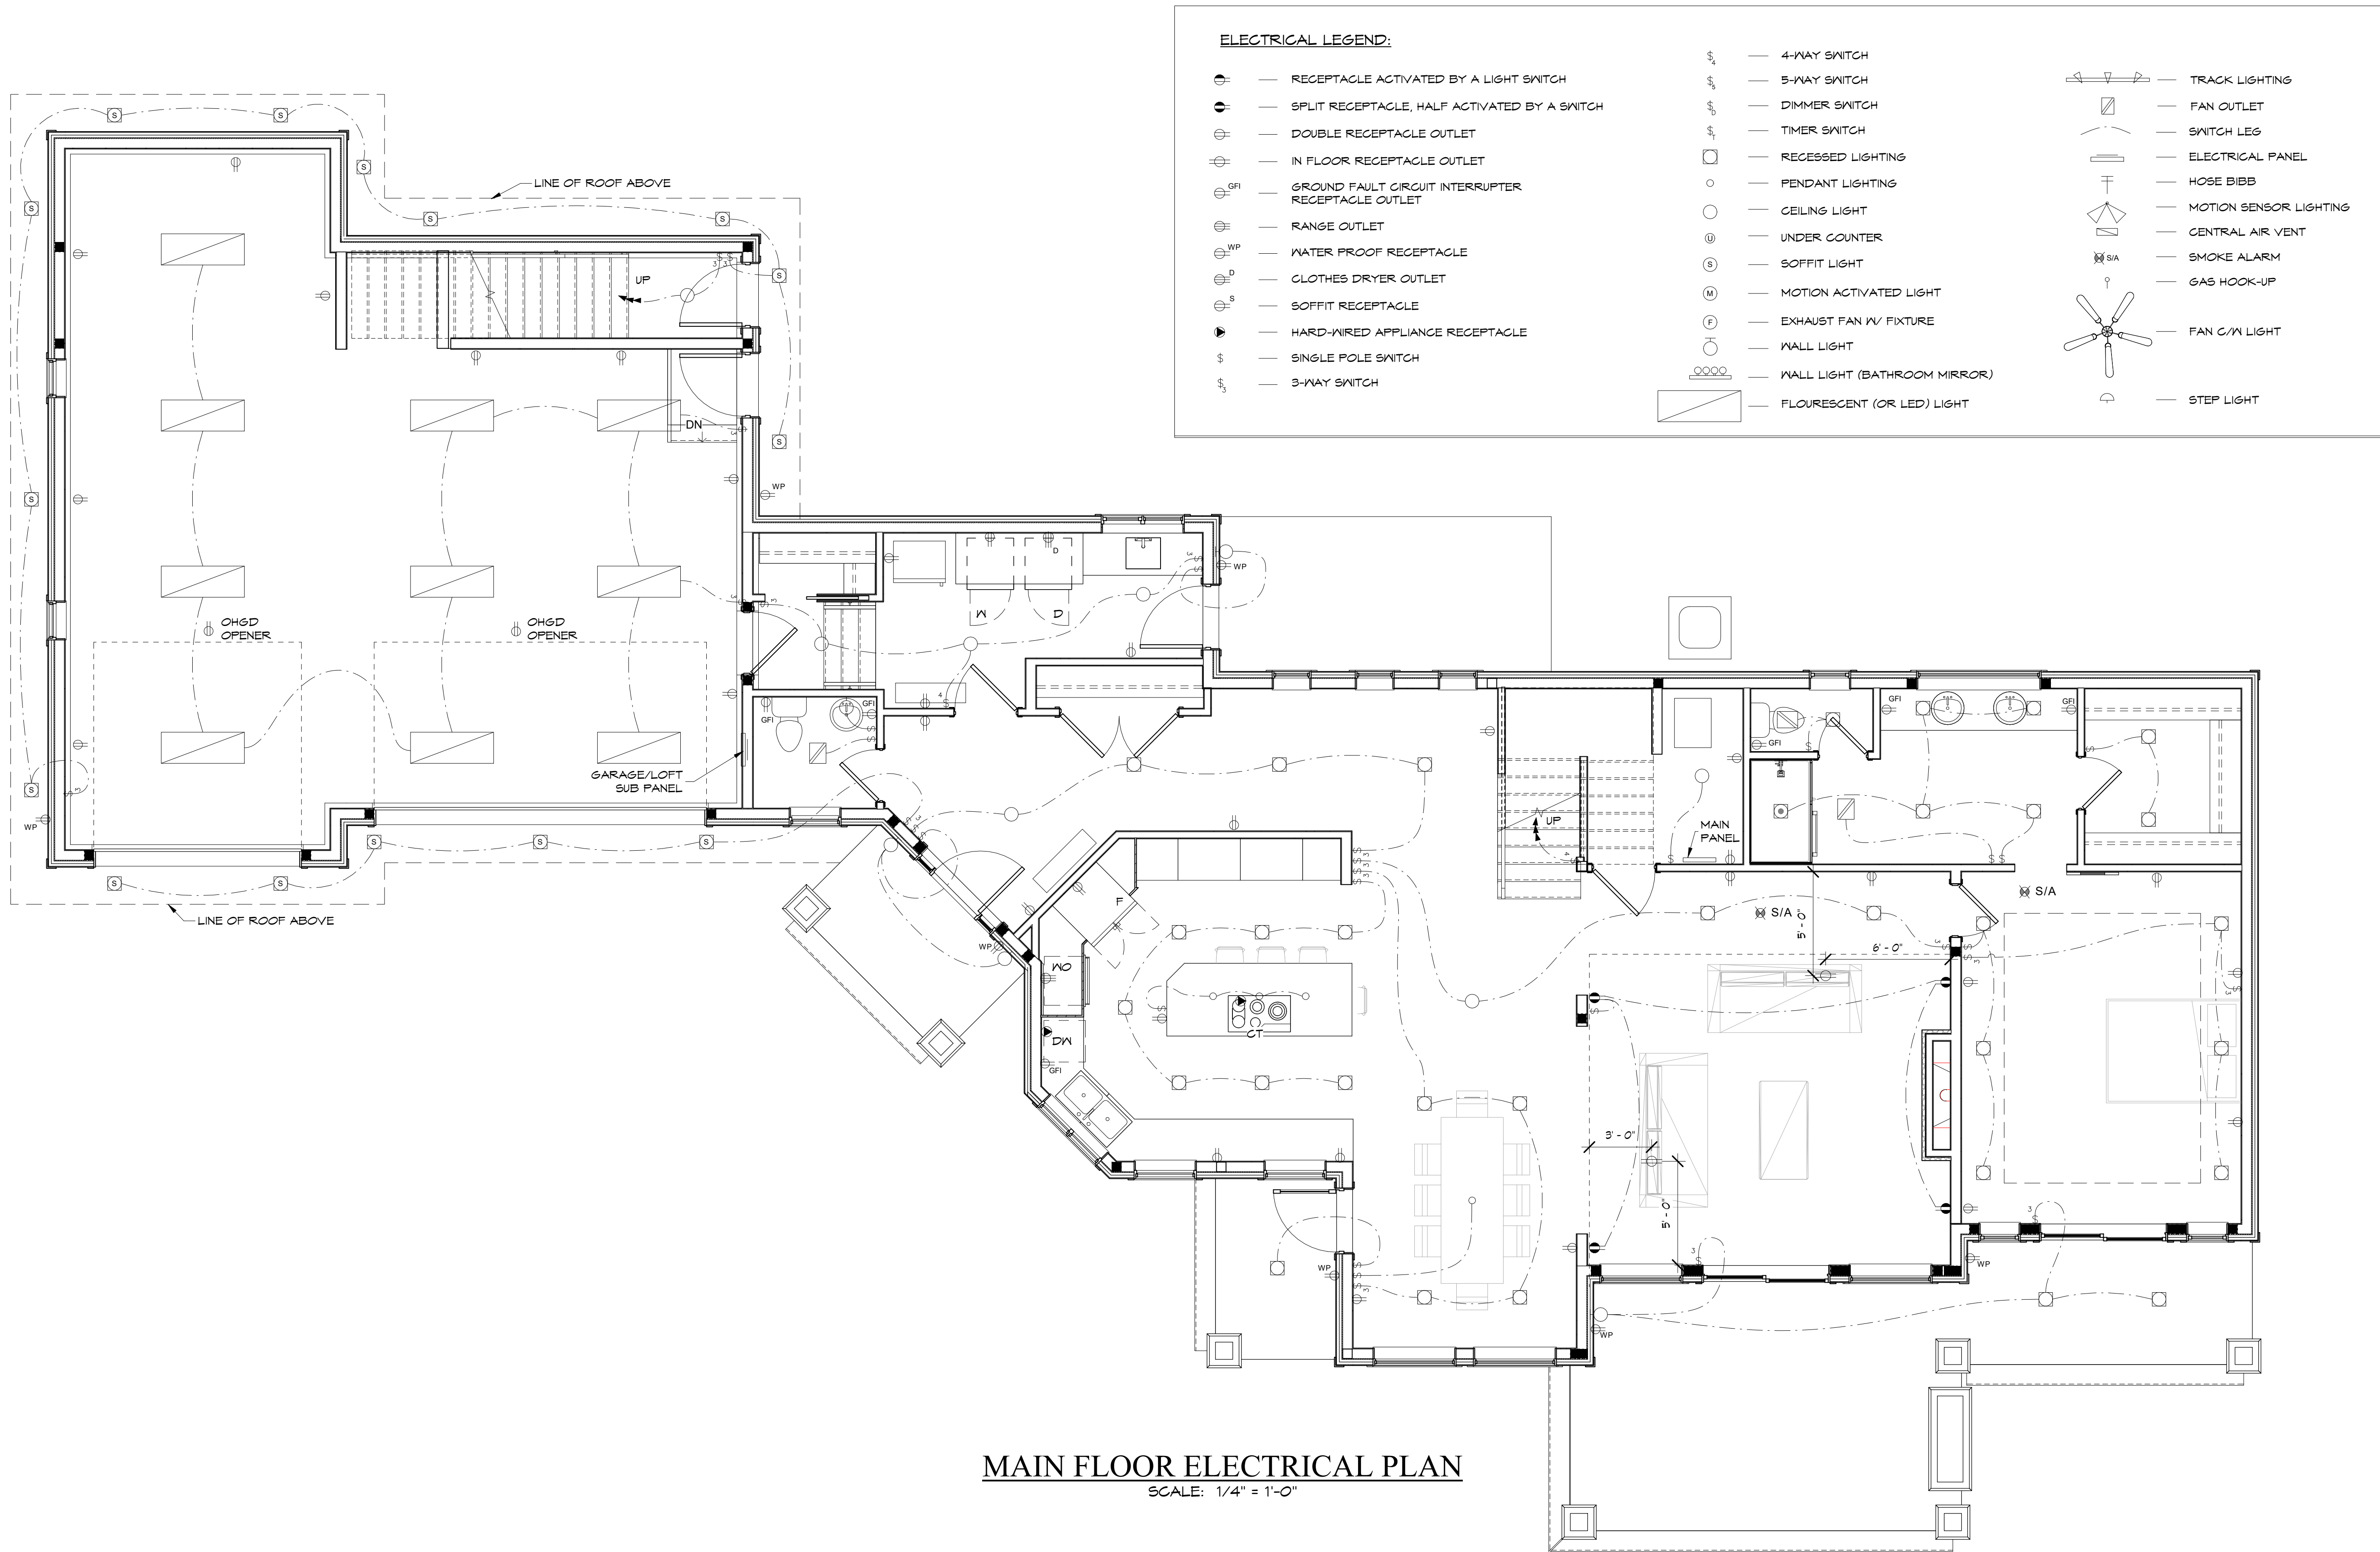

MAIN FLOOR ELECTRICAL PLAN  
SCALE: 1/4" = 1'-0"

ELECTRICAL LEGEND:

- RECEPTACLE ACTIVATED BY A LIGHT SWITCH
- SPLIT RECEPTACLE, HALF ACTIVATED BY A SWITCH
- DOUBLE RECEPTACLE OUTLET
- IN FLOOR RECEPTACLE OUTLET
- GROUND FAULT CIRCUIT INTERRUPTER RECEPTACLE OUTLET
- RANGE OUTLET
- WATER PROOF RECEPTACLE
- CLOTHES DRYER OUTLET
- SOFFIT RECEPTACLE
- HARD-WIRED APPLIANCE RECEPTACLE
- SINGLE POLE SWITCH
- 3-WAY SWITCH
- 4-WAY SWITCH
- 5-WAY SWITCH
- DIMMER SWITCH
- TIMER SWITCH
- RECESSED LIGHTING
- PENDANT LIGHTING
- CEILING LIGHT
- UNDER COUNTER
- SOFFIT LIGHT
- MOTION ACTIVATED LIGHT
- EXHAUST FAN W/ FIXTURE
- MALL LIGHT
- MALL LIGHT (BATHROOM MIRROR)
- FLOURESCENT (OR LED) LIGHT
- TRACK LIGHTING
- FAN OUTLET
- SWITCH LEG
- ELECTRICAL PANEL
- HOSE BIBB
- MOTION SENSOR LIGHTING
- CENTRAL AIR VENT
- SMOKE ALARM
- GAS HOOK-UP
- FAN C/W LIGHT
- STEP LIGHT

NOTE TO GENERAL CONTRACTOR  
QUESTIONS REGARDING THE DESIGN ARE WELCOME.  
PLEASE FEEL FREE TO DIRECT ANY QUESTIONS  
REGARDING THE DESIGN TO OUR OFFICE AT  
828-0321. PROJECT MANAGER AND  
DESIGNER IS IVORY WINSTON

NO.	REVISION	DATE	BY
5	UPDATED PERMIT ISSUE	16JUL21	I.W.
4	ISSUED FOR PERMIT	08JUN21	I.W.
3	ISSUED FOR PRICING	01MAR21	I.W.



#101-1402 McGill Road, Kamloops, BC  
V2C 1L3; 250-828-0321

A11	PROJECT	ADKINS CUSTOM
	APPROVED	I.W.
	SCALE	AS NOTED
	DATE	JAN 2021

CLIENT  
ADKINS, MIKE


TITLE  
ELECTRICAL PLANS

JOB NUMBER	40K05	A11 OF 12	5
		DWG NO.	REV


CANCEL ALL PRINTS BEARING EARLIER REVISION

REVISED 07/27/21  
MONTH DAY YEAR




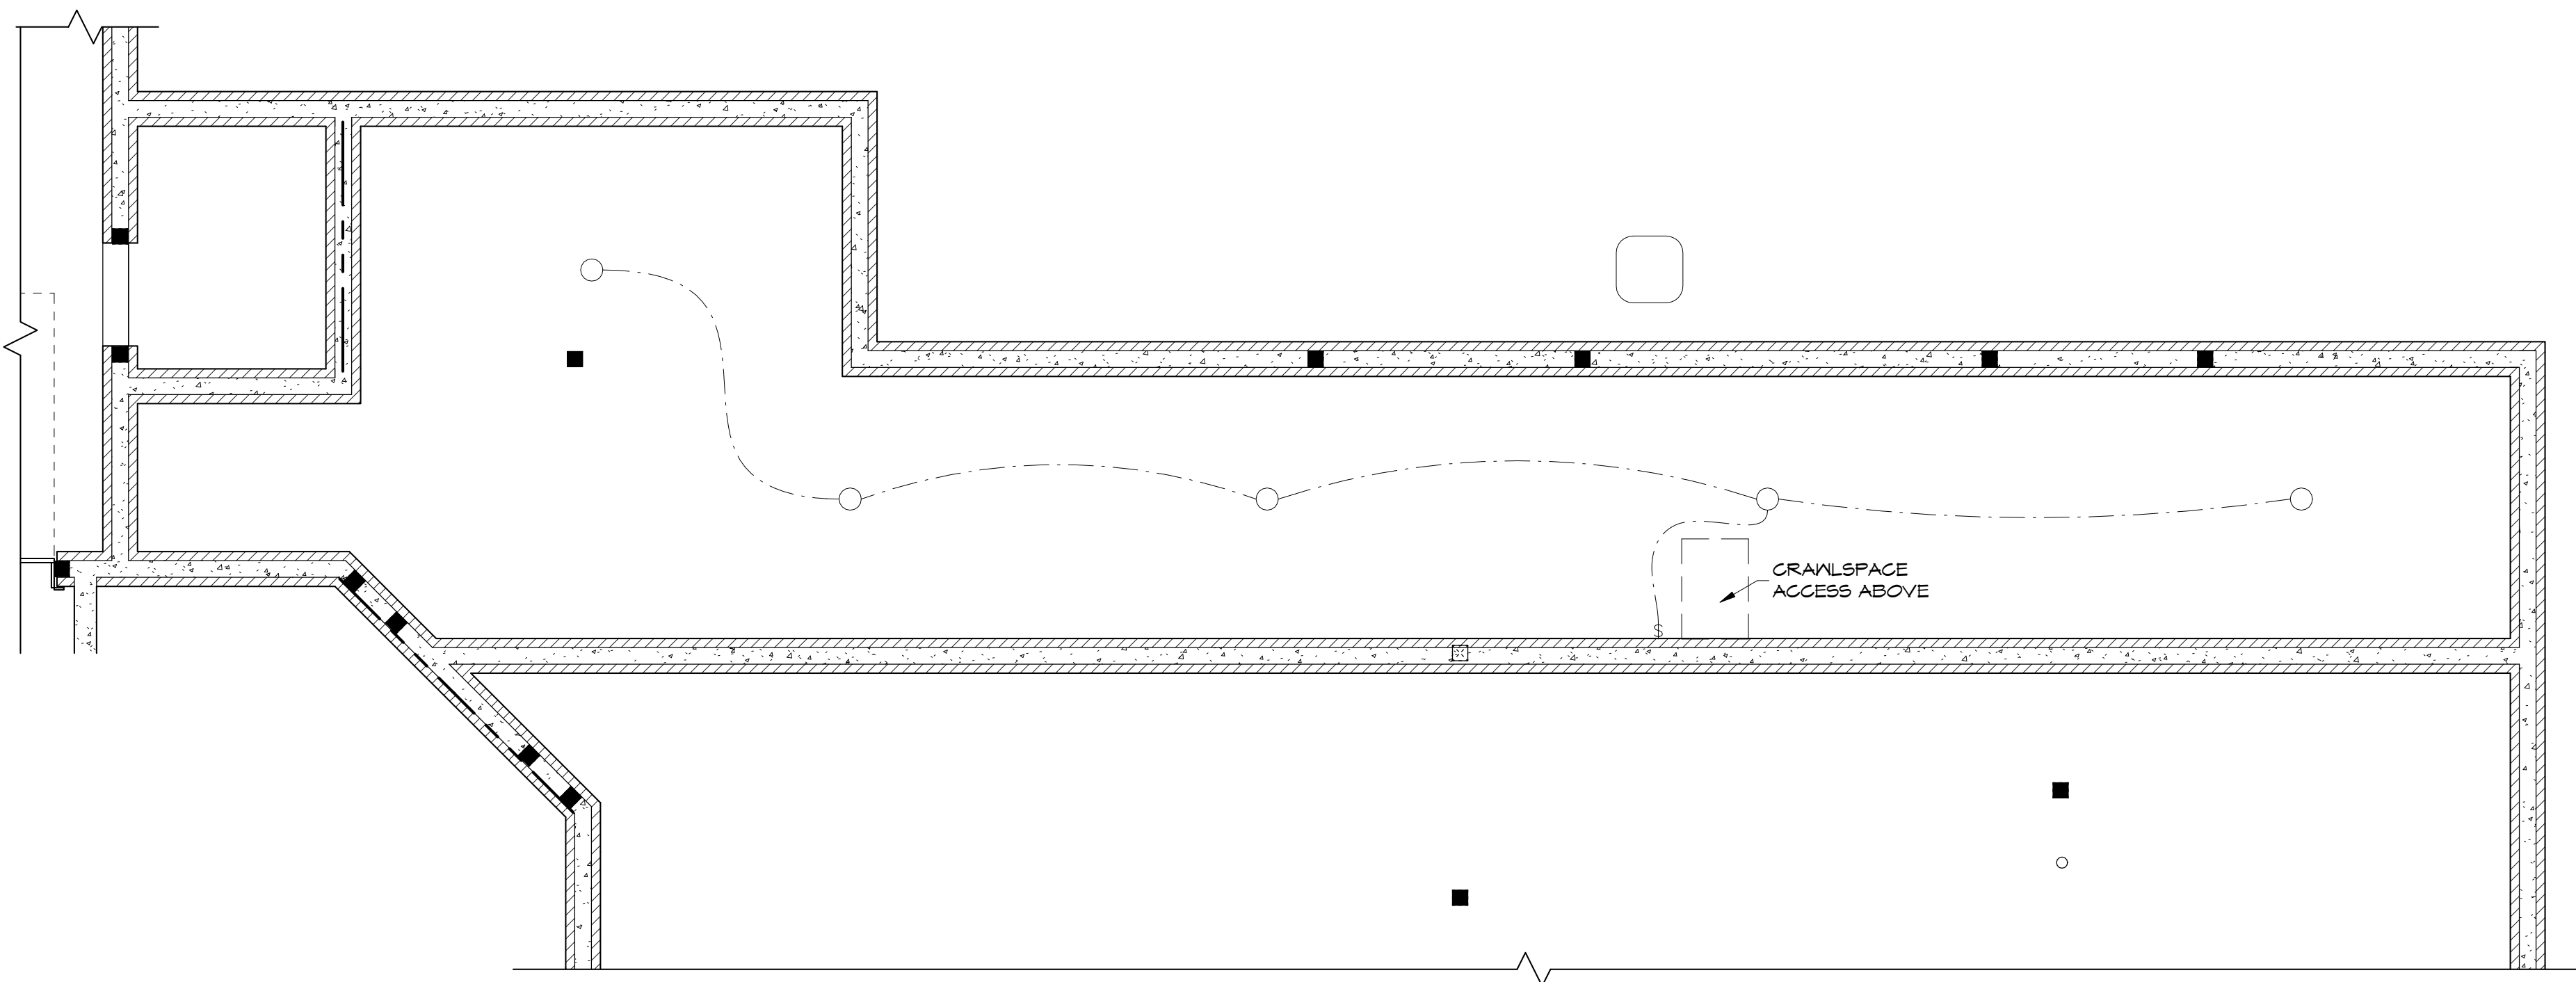

CRAWLSPACE ELECTRICAL PLAN  
SCALE: 1/4" = 1'-0"

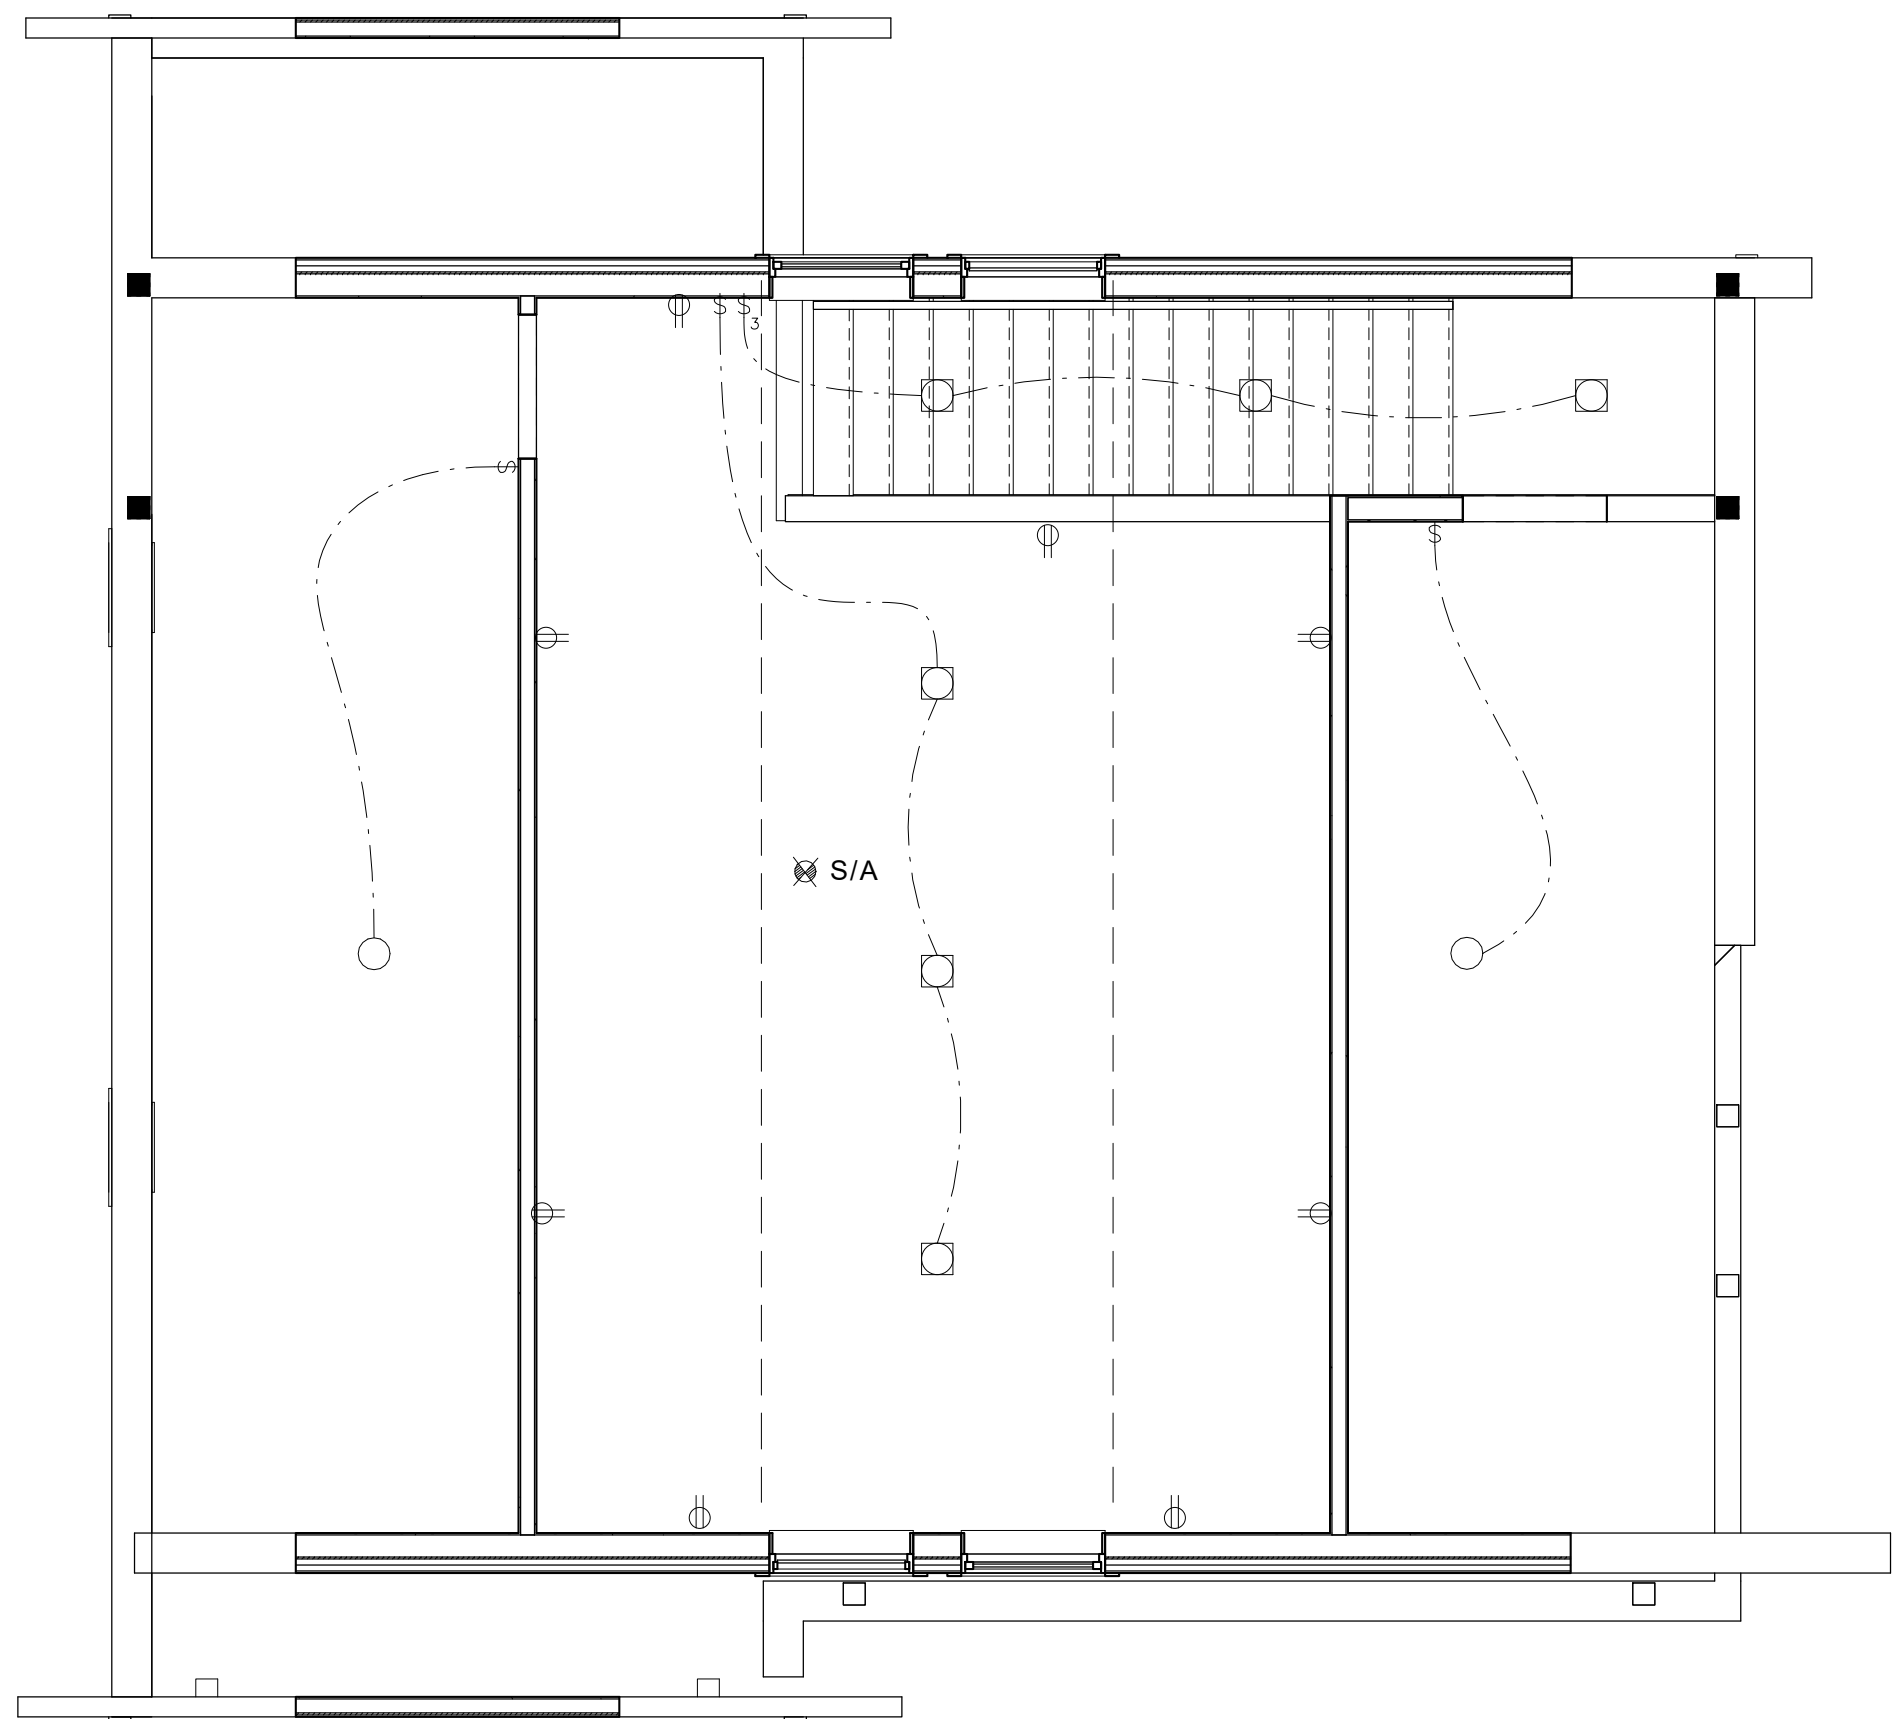

UPPER FLOOR ELECTRICAL PLAN  
SCALE: 1/4" = 1'-0"

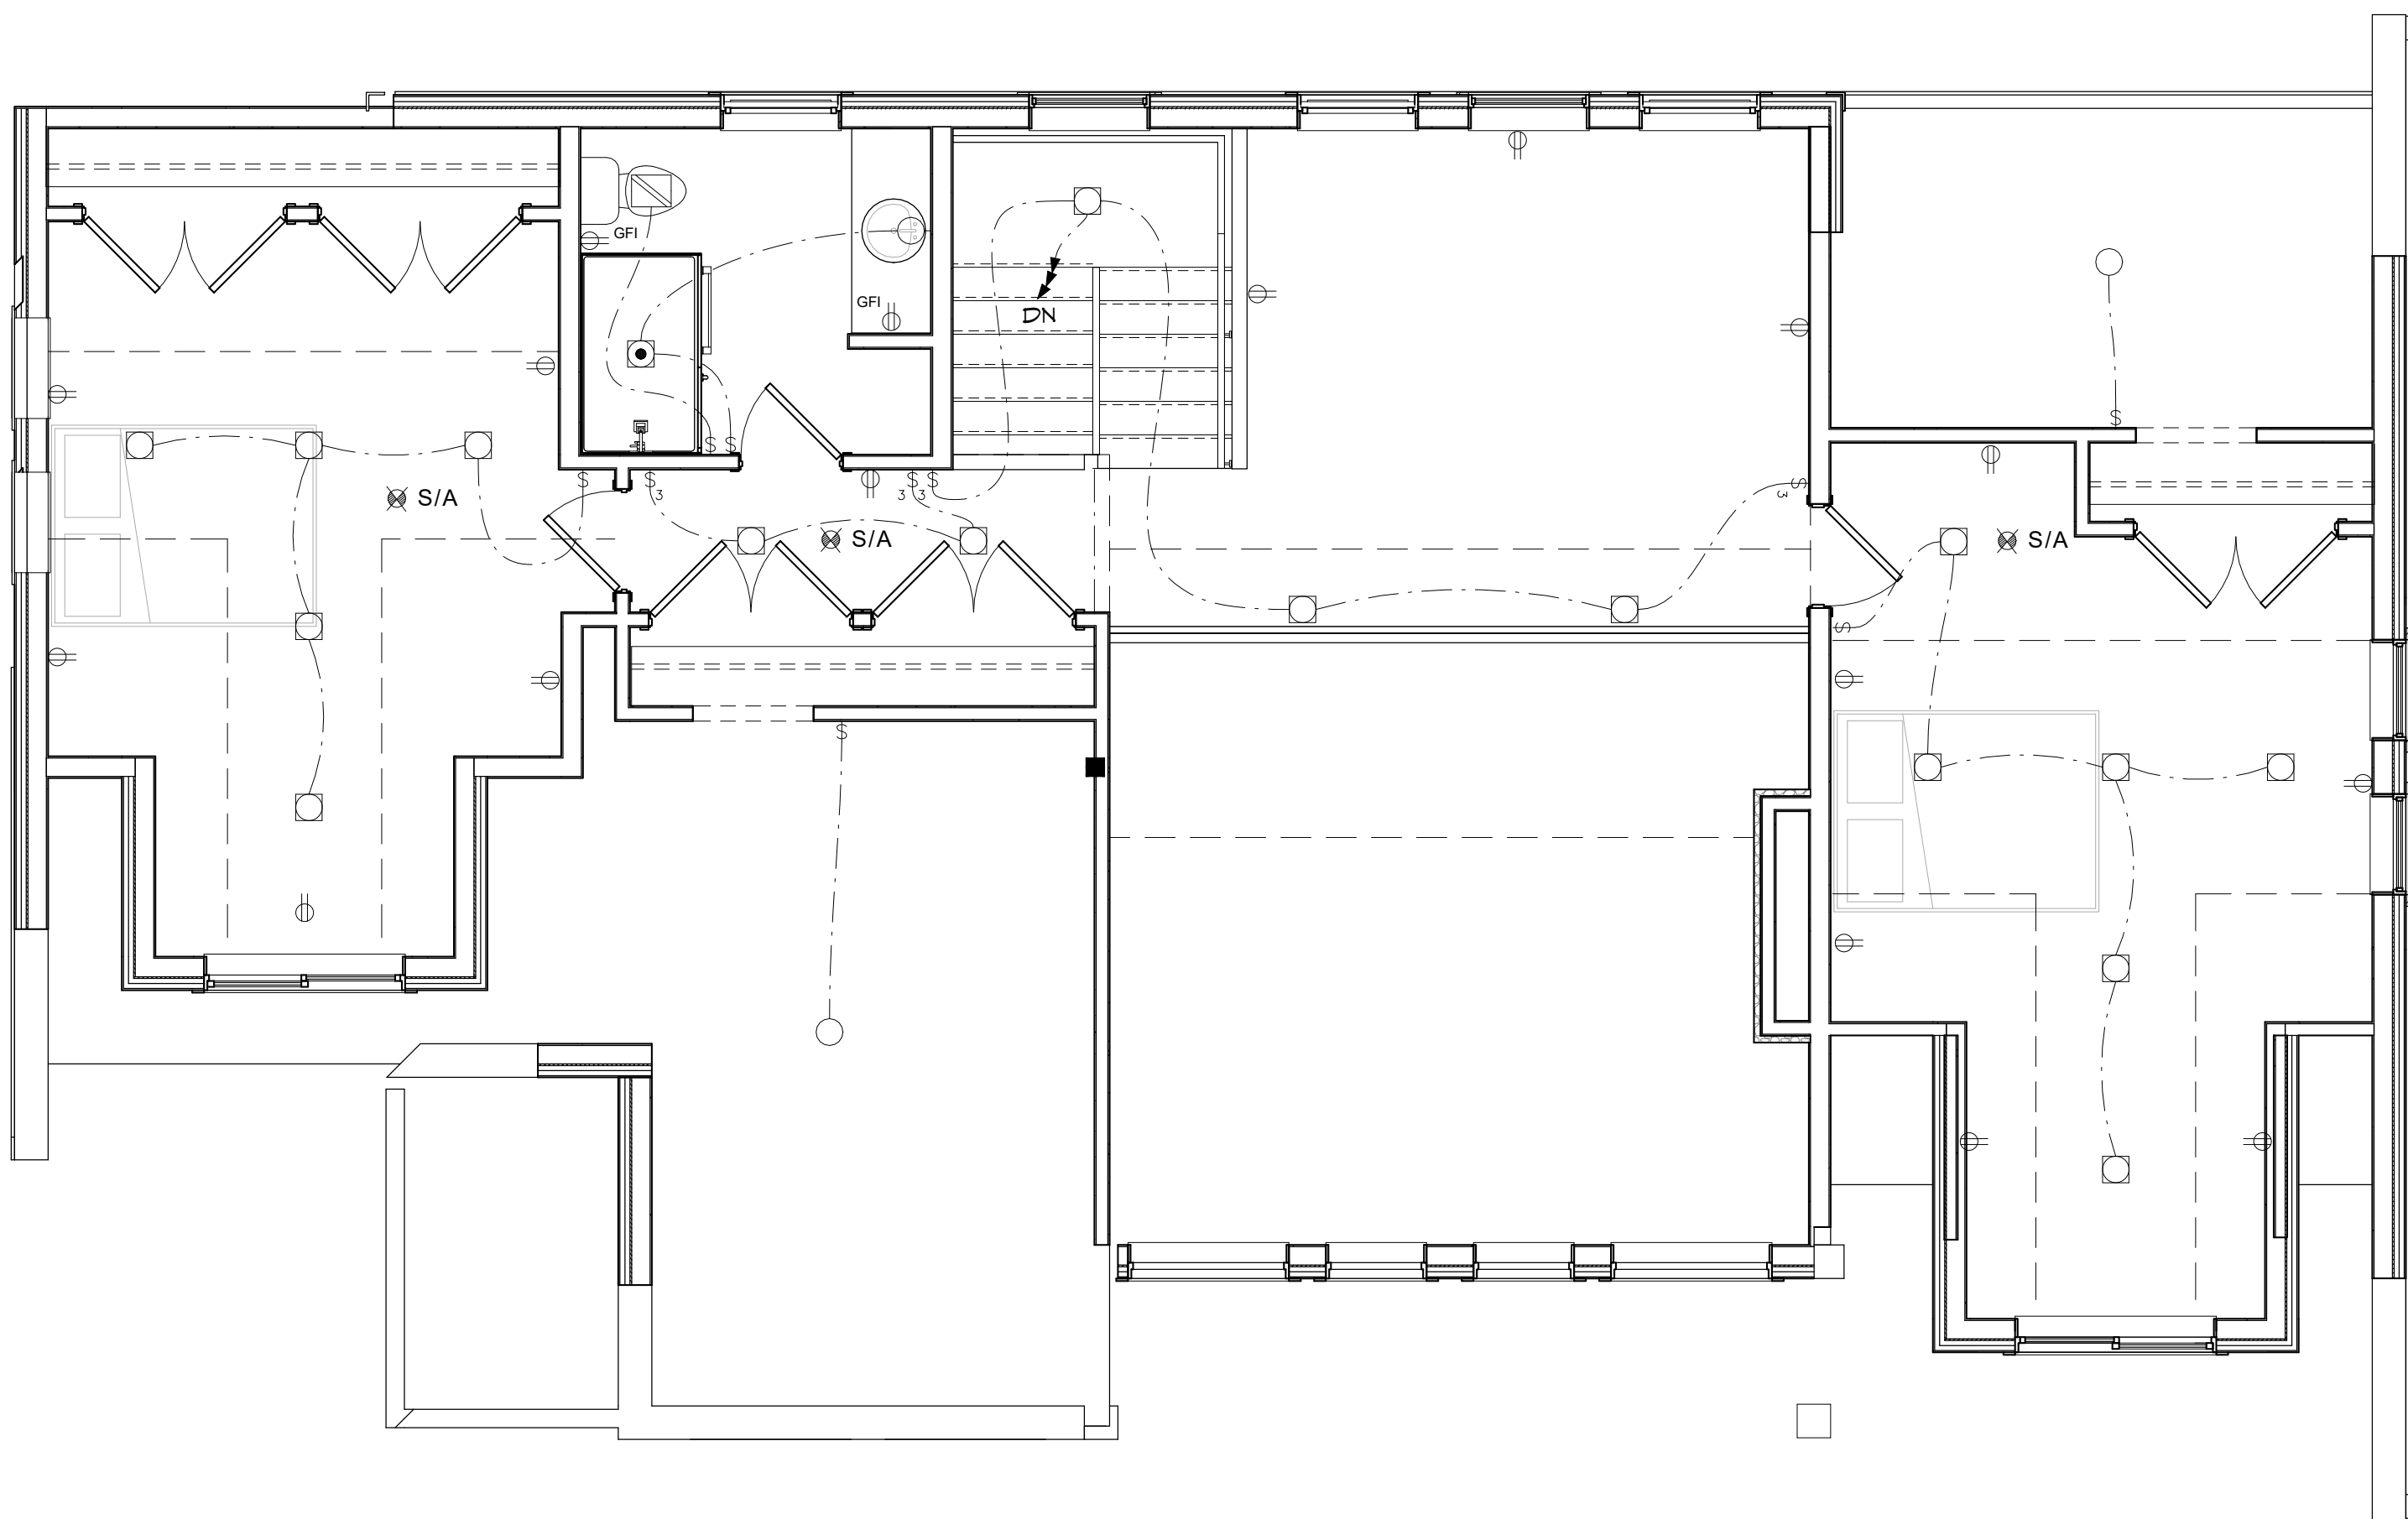

REVISED 07/27/21  
MONTH DAY YEAR

NO.	REFERENCE DRAWINGS

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#101-1402 McGill Road, Kamloops, BC  
V2C 1L3; 250-828-0321

DRAWN S.S.	PROJECT ADKINS CUSTOM
	APPROVED I.W.
	SCALE AS NOTED
FILED	DATE JAN 2021

CLIENT  
ADKINS, MIKE

TITLE  
ELECTRICAL PLANS

JOB NUMBER 40K05	A12 OF 12 DWS NO.	5 REV
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CANCEL ALL PRINTS BEARING EARLIER REVISION