SHEET LEGEND A1 - SITE PLAN & NOTES A2 - ELEVATIONS A3 - FOUNDATION A4 - LOWER FLOOR PLAN A5 - UPPER FLOOR PLAN A6 - ROOF & DETAILS A7 - SECTIONS & SCHEDULES

Q J J S O

16.38m

23'-2<u>1</u>" [7.06m]

LOT SETBACKS

FRONT - 6M FRONTAGE 16M LIMITING DIST. TO CENTER OF ROAD Back - 6M 6.1-6.2m LIMITING DIST. TO REAR P.L. SIDE 1.5M 9.7-10.1M LIMITING DIST. RIGHT P.L. 1.53-6.59M LIMITING DIST. LEFT P.L.

20'4" 20'4" 20mJ

19 AVE. SE

C:\User\User\Desktop\Wood Creek Construction\Custom Projects\Green, Denise & Fred\Green, Denise & Fred - 2022 03 31 - Final Plans.dwg, 2022-06-28 10:32:07 AM, _AutoCAD PDF (General Documentation).pc3

LOT COVERAGE:

LOT AREA: 10649 SQ FT.


MAIN FLOOR AREA: 1606 SQ FT.

DEV. BASEMENT FLOOR: 1726 SQ FT.

SUITE AREA - N/A TOTAL FOOTPRINT AREA: 2989 SQ FT.

RATIO: 28.1%

ALLOWABLE: 40.0%

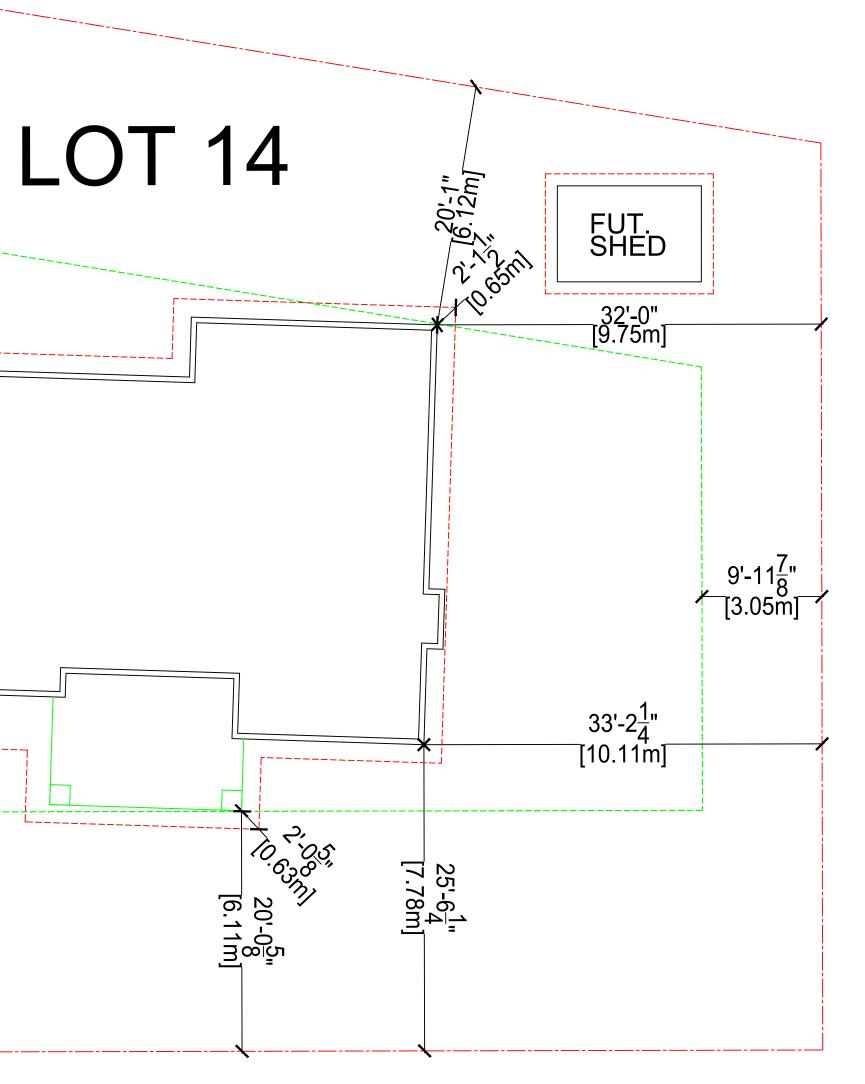

SITE PLAN

NOTE: GEOMATIC/SURVEY/GRADES REQ'D

GENERAL NOTES

- ZONING, AND BYLAWS THAT MAY APPLY.
- **CREEK IMMEDIATELY**
- **EXCEPTION OF WALL STUDS**
- DAYS.
- **BITUMINOUS MATERIAL.**
- RADON GAS UNDER INTERIOR SLABS.
- ACCORDING TO LOCAL STANDARDS.
- TO BUILDING.
- FABRICATION.
- SERVICES WITHIN BUILDING ENVELOPE.

- FLOOR TO BE CONSTRUCTED OF SAFETY GLASS.

- BY APPROPRIATE LOCAL MUNICIPALITY.

ALL CONSTRUCTION MATERIALS & WORKMANSHIP TO BE IN ACCORDANCE WITH THE CURRENT EDITION OF THE B.C. BUILDING CODE PLUMBING CODE, ELECTRICAL CODE, AND ALL OTHER CODES,

2. THE CONTRACTOR AND ALL SUB-TRADES ARE RESPONSIBLE FOR THE REVIEW OF ALL DRAWINGS AND SITE CONDITIONS PRIOR TO COMMENCING WORK OR ORDERING ANY MATERIAL, AND SHALL REPORT AND DISCREPANCIES THAT AFFECT DESIGN TO WOOD

3. ALL FRAMING MATERIAL TO BE S.P.F. #2 OR BETTER WITH THE

4. CONCRETE FOOTINGS AND WALLS TO BE A MINIMUM 28MPA @28 DAYS. FLOOR SLABS AND SIDEWALKS TO BE MINIMUM 32MPA @ 28

5. ALL CONCRETE FOOTINGS TO BE PLACED ON ORIGINAL UNDISTURBED GROUND, FREE OF ALL ORGANIC, FROZEN OR FROSTY MATERIAL.

6. DAMP PROOF FOUNDATION WALLS BELOW GRADE WITH 2 COATS OF

7. 6 MIL. ULTRAVIOLET RESISTANT POLY VAPOUR BARRIER ON A.) 4" OF GRANULAR COMPACTABLE FILL UNDER EXTERIOR OR GARAGE SLABS. OR B.) 4" OF $\frac{3}{4}$ " DRAIN ROCK OR OTHER MATERIAL SUITABLE FOR MOVEMENT OF

8. ALL FOUNDATION DRAINS TO BE 4" PERFORATED P.V.C. WITH FILTER CLOTH AND MINIMUM 6" DRAIN ROCK, DRAINED TO MUNICPAL SERVICES

9. GRADE TO BE SLOPED AWAY FROM BUILDING AT ALL LOCATIONS ADJACENT

10. ALL TRUSSES I-JOISTS, BEAMS OR OTHER STRUCTURAL MEMBERS NOT COVERED IN B.C. BUILDING CODE TO BE DESIGNED AND ENGINEERED BY TRUSS MANUFACTURER OR STRUCTURAL ENGINEER PRIOR TO ANY

11. CONTRACTOR TO VERIFY ALL PROPERTY AND FOUNDATION LINES WITH A LEGAL LAND SURVEYOR PRIOR TO PLACING FOOTINGS OR RUNNING

12. ALL ROOF SPACES TO BE VENTILATED WITH SOFFIT AND ROOF VENTS WITH A MINIMUM DISTRIBUTION AREA OF 1/300. A MINIMUM OF 25% OF VENTS TO BE LOCATED AT ROOF. MINIMUM 25% TO BE LOCATED AT SOFFIT.

13. DOOR FRAMES AT ENTRANCES AND EXTERIOR SPACES TO DWELLING UNITS SHALL BE SOLIDLY BLOCKED BETWEEN DOOR FRAME AND STUDS AT THE HEIGHT OF THE DEADBOLT TO RESIST SPREADING.

14. ALL GLASS IN DOORS, SIDELITES OR WINDOWS WITHIN 12" OF FINISHED


15. RAIN WATER LEADERS NOT SHOWN ON PLAN . CONTRACTOR TO DETERMINE EXACT LOCATION SUITABLE TO SITE AND MUNICIPAL DRAINAGE.

16. ELECTRICAL LOCATIONS TO BE DETERMINED BY ELECTRICAL CONTRACTOR WITH THE APPROVAL OF THE HOME OWNER OR GENERAL CONTRACTOR AND IN ACCORDANCE WITH CURRENT ELECTRICAL CODE.

17. APPROVED SMOKE ALARMS TO BE INSTALLED WITH LOCATION APPROVED


18. REFER TO LAOUTS AND SPECIFICATIONS FROM STRUCTURAL ENGINEER, FLOOR JOIST SUPPLIER, AND ROOF TRUSS MANUFACTURER FOR BEAM, POST, FOOTING LOCATIONS AND SIZES. ENSURE PROPER BEARING IS PROVIDED FOR ALL POINT LOADS. ANY STRUCTURAL SPECIFICATIONS SHOWN ON WOOD CREEK PLANS ARE ESTIMATES ONLY AND MAY NOT ACCURATELY REPRESENT LOADING AND SIZING, OR MAY NOT INCLUDE POINT LOADS OR STRUCTURAL MEMBERS DESIGNED BY OTHERS.

	NOTE: ALL CONSTRUCTION SHALL						
	CONFORM TO ALL APPLICABLE LOCAL CODES AND BYLAWS. DESIGN OF						
	FOUNDATION AND FOOTINGS TO BE						
	MODIFIED TO SUIT LOCAL SOIL CONDITIONS AS REQUIRED						
			E DRAWINGS. WRITTEN				
			HALL TAKE PRECEDENCE. G IS THE PROPERTY OF				
			CONSTRUCTION AND MAY				
			Y FOR THE PURPOSE FOR OANED BY THE COMPANY				
	vviii						
	1	MAY 27/22	ELEVATOR REMOVED				
	2	JUNE 3/22	WINDOWS REVISED COV. CONC. DECK WINDOWS REVISED				
	3	JUNE 15/22 JUNE 28/22	GUEST/LAUNDRY ROOM WIN. STAIR REVISIONS				
	4	JUINE 20/22	STAIR REVISIONS				
	<u> </u>						
	<u> </u>						
	<u> </u>						
	<u> </u>						
	<u> </u>						
	<u> </u>						
	NO.	DATE	DECODIDITION				
- -		!	DESCRIPTION				
	REVIS	SIONS	DESCRIPTION				
	REVIS	SIONS	DESCRIPTION				
	REVIS	SIONS	DESCRIPTION				
	REVIS	SIONS					
	REVIS	SIONS					
	REVIS	SIONS					
	REVIS	SIONS					
	REVIS	SIONS	DESCRIPTION				
		V00	d Creek				
	V	Voo Cons	d Creek truction Ltd.				
	V	Voo Cons	d Creek				
	V	Voo Cons	d Creek truction Ltd.				
	V	Voo Cons Suilding	d Creek truction Ltd.				
	V	Voo Cons Suilding	d Creek truction Ltd. with Confidence -				
	V	Voo Cons Suilding CIV	d Creek truction Ltd. with Confidence -				
	V	Voo Cons Suilding CIV	A Creek truction Ltd. with Confidence -				
	V	Voo Cons Suilding CIV	A Creek truction Ltd. with Confidence -				
	V -B	Voo Cons Suilding CIV 1170 19th	A Creek truction Ltd. with Confidence -				
	V	Voo Cons Suilding CIV 1170 19th	A Creek truction Ltd. with Confidence -				
	V -B	Voo Cons Suilding 1170 19th	A Creek truction Ltd. with Confidence -				
	V -B	Voo Cons Suilding CIV 1170 19th	A creak truction Ltd. with Confidence - VIC ADDRESS A ve. SE Salmon Arm				
	V -B	Voo Cons Suilding CIV 1170 19th	A Creek truction Ltd. with Confidence -				
	V -B PROJECT	VOO Cons Suilding CIV 1170 19th	Ave. SE Salmon Arm				
	V -B PROJECT	VOO Cons Suilding CIV 1170 19th	A creak truction Ltd. with Confidence - VIC ADDRESS A ve. SE Salmon Arm				
	V -B PROJECT	VOO Cons Suilding CIV 1170 19th	Ave. SE Salmon Arm				
	V -B PROJECT	VOO Cons Suilding CIV 1170 19th	Ave. SE Salmon Arm				
	V -B PROJECT	VOO Cons Suilding CIV 1170 19th	Ave. SE Salmon Arm				
	V -B PROJECT	VOO Cons Suilding CIV 1170 19th	Ave. SE Salmon Arm				
	PROJECT CUSTOM SHEET TI	VOO Cons Suilding CIV 1170 19th	Ave. SE Salmon Arm BREEN BREEN BREEN				
	PROJECT CUSTOM SHEET TI SCALE	VOCONS Duilding CIV 1170 19th INO. ER ESTEE GE NU UNE 28/22	Ave. SE Salmon Arm BREEN BREEN BREEN				
	PROJECT CUSTOM SHEET TI SCALE	VOO Cons Suilding IITO 19th IITO 19th IITO 19th IITE SITE GE GE	Ave. SE Salmon Arm				
	PROJECT CUSTOM SHEET TI SCALE	INO.	Ave. SE Salmon Arm BREEN BREEN BREEN				

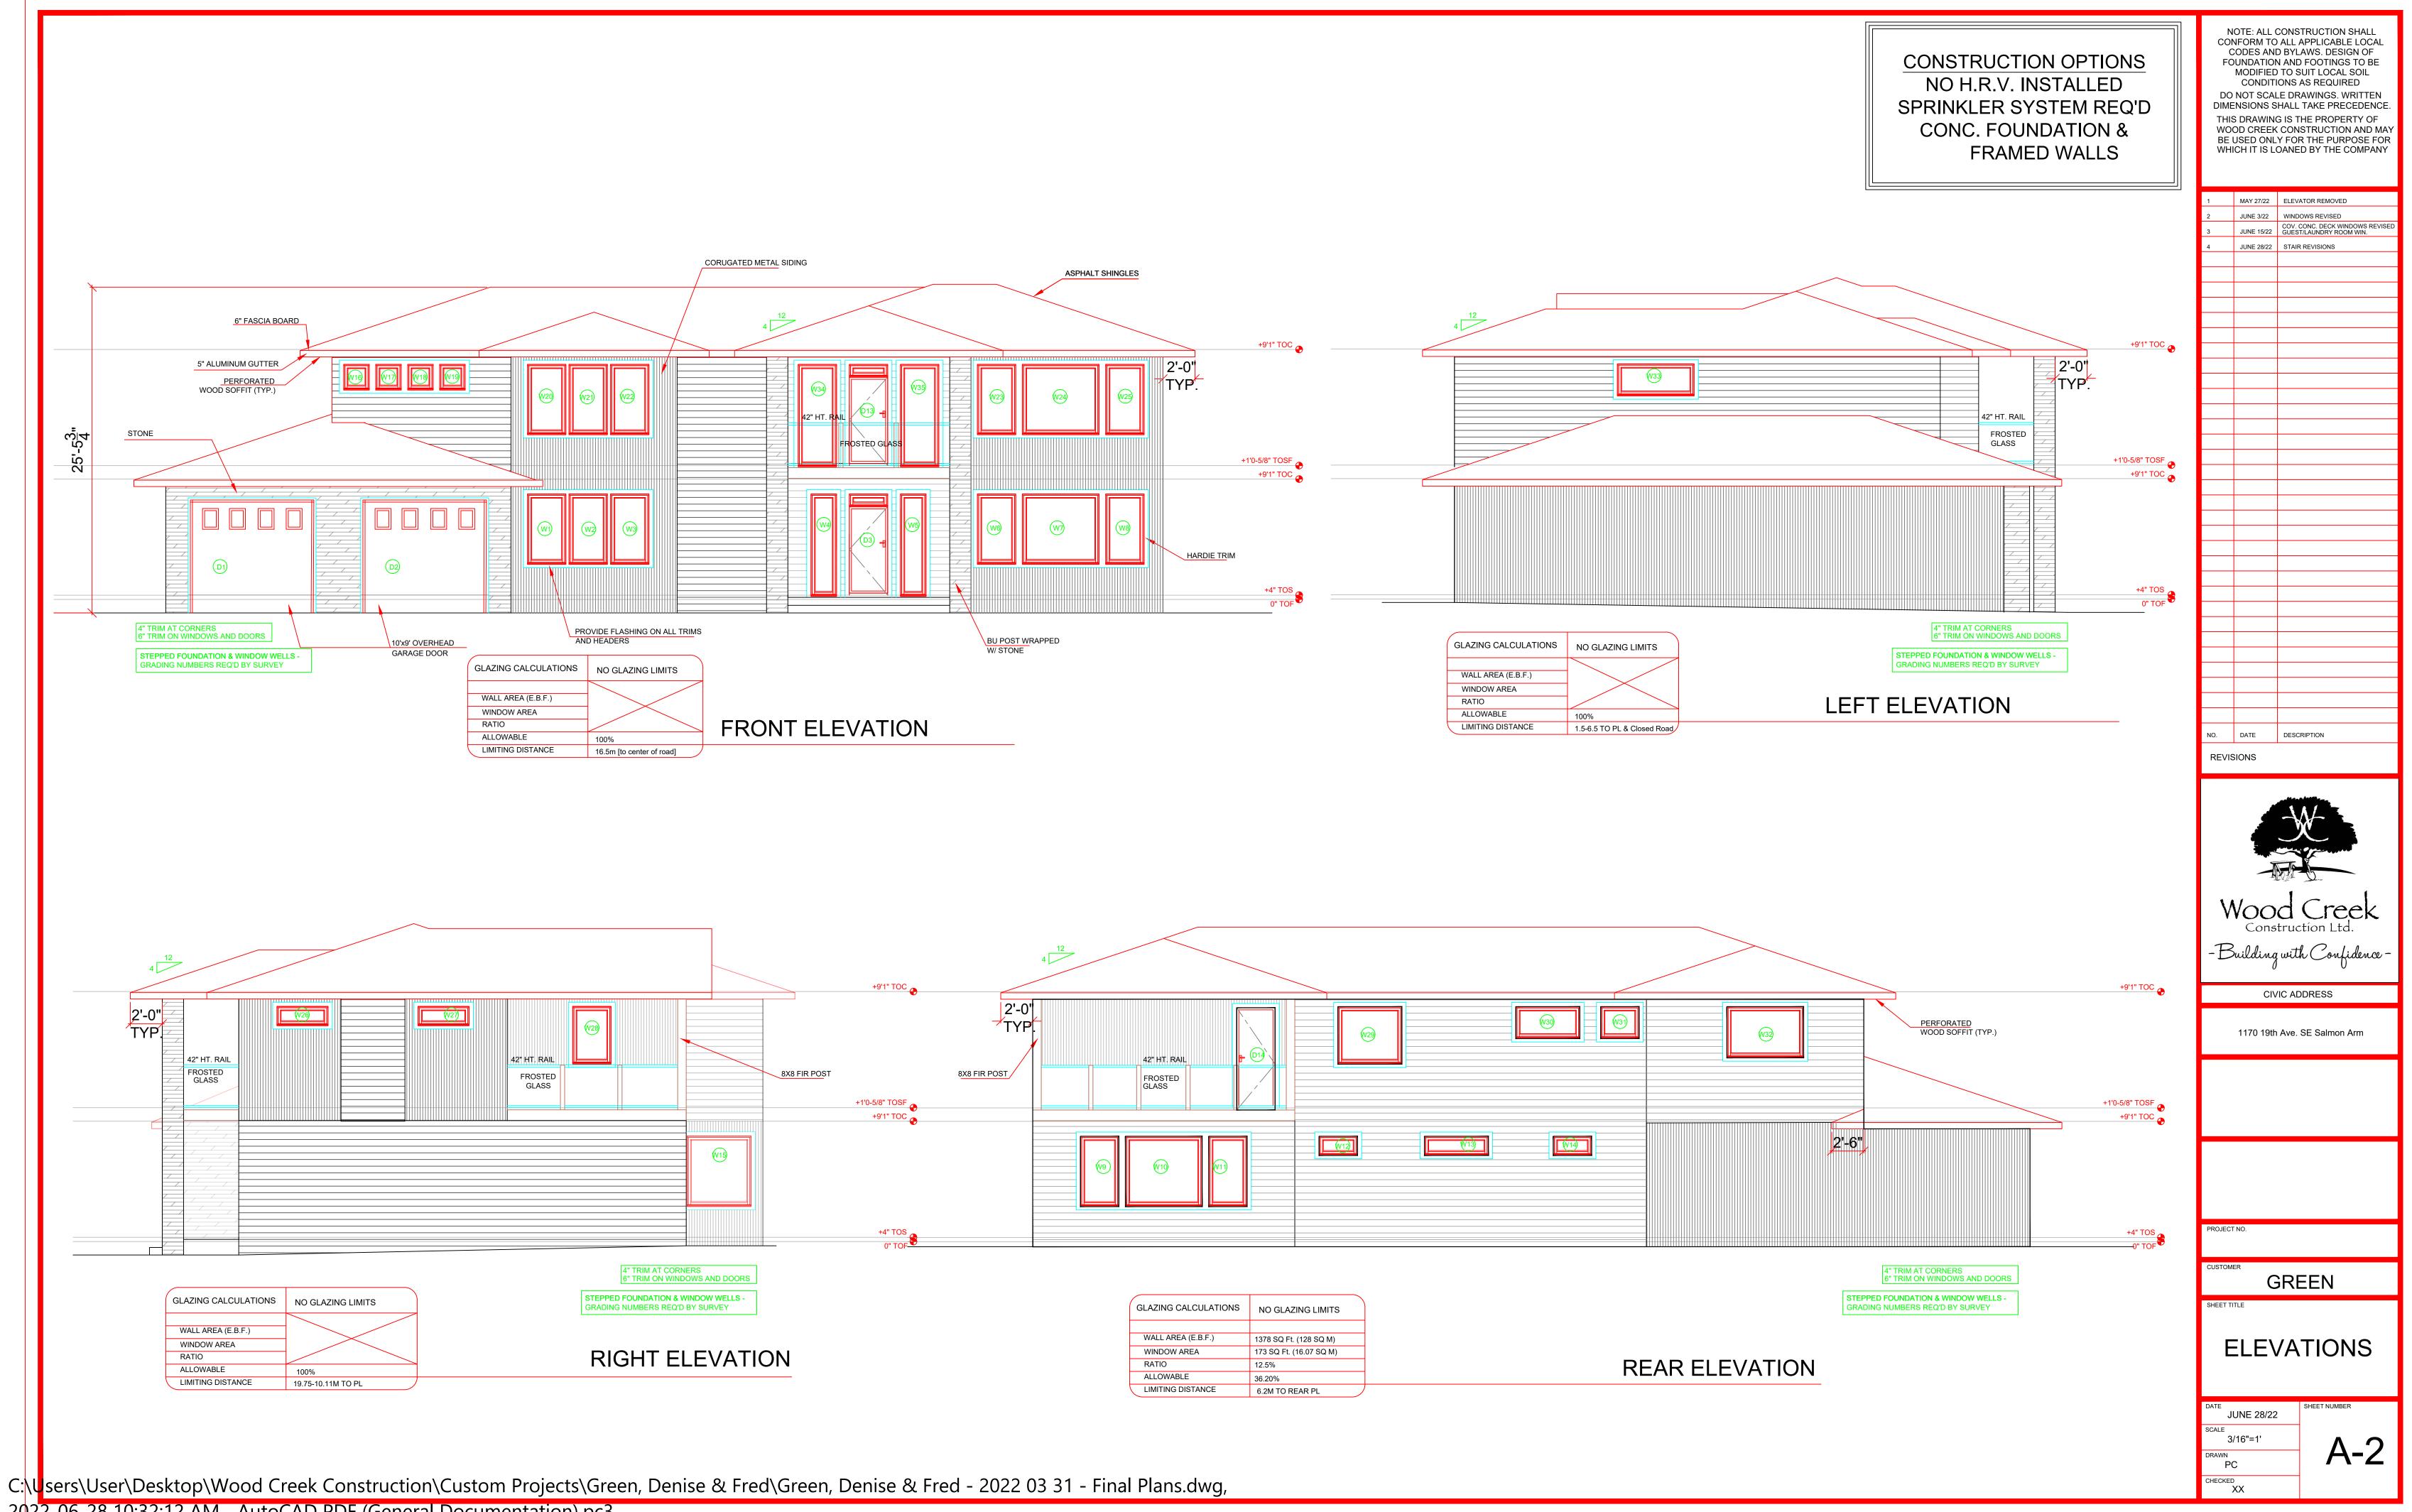


2022-06-28 10:32:12 AM, _AutoCAD PDF (General Documentation).pc3

GLAZING CALCULATIONS	NO GLAZING LIMITS			
WALL AREA (E.B.F.)	1378 SQ Ft. (128 SQ M)			
WINDOW AREA	173 SQ Ft. (16.07 SQ M)			
RATIO	12.5%			
ALLOWABLE	36.20%			
LIMITING DISTANCE	6.2M TO REAR PL			

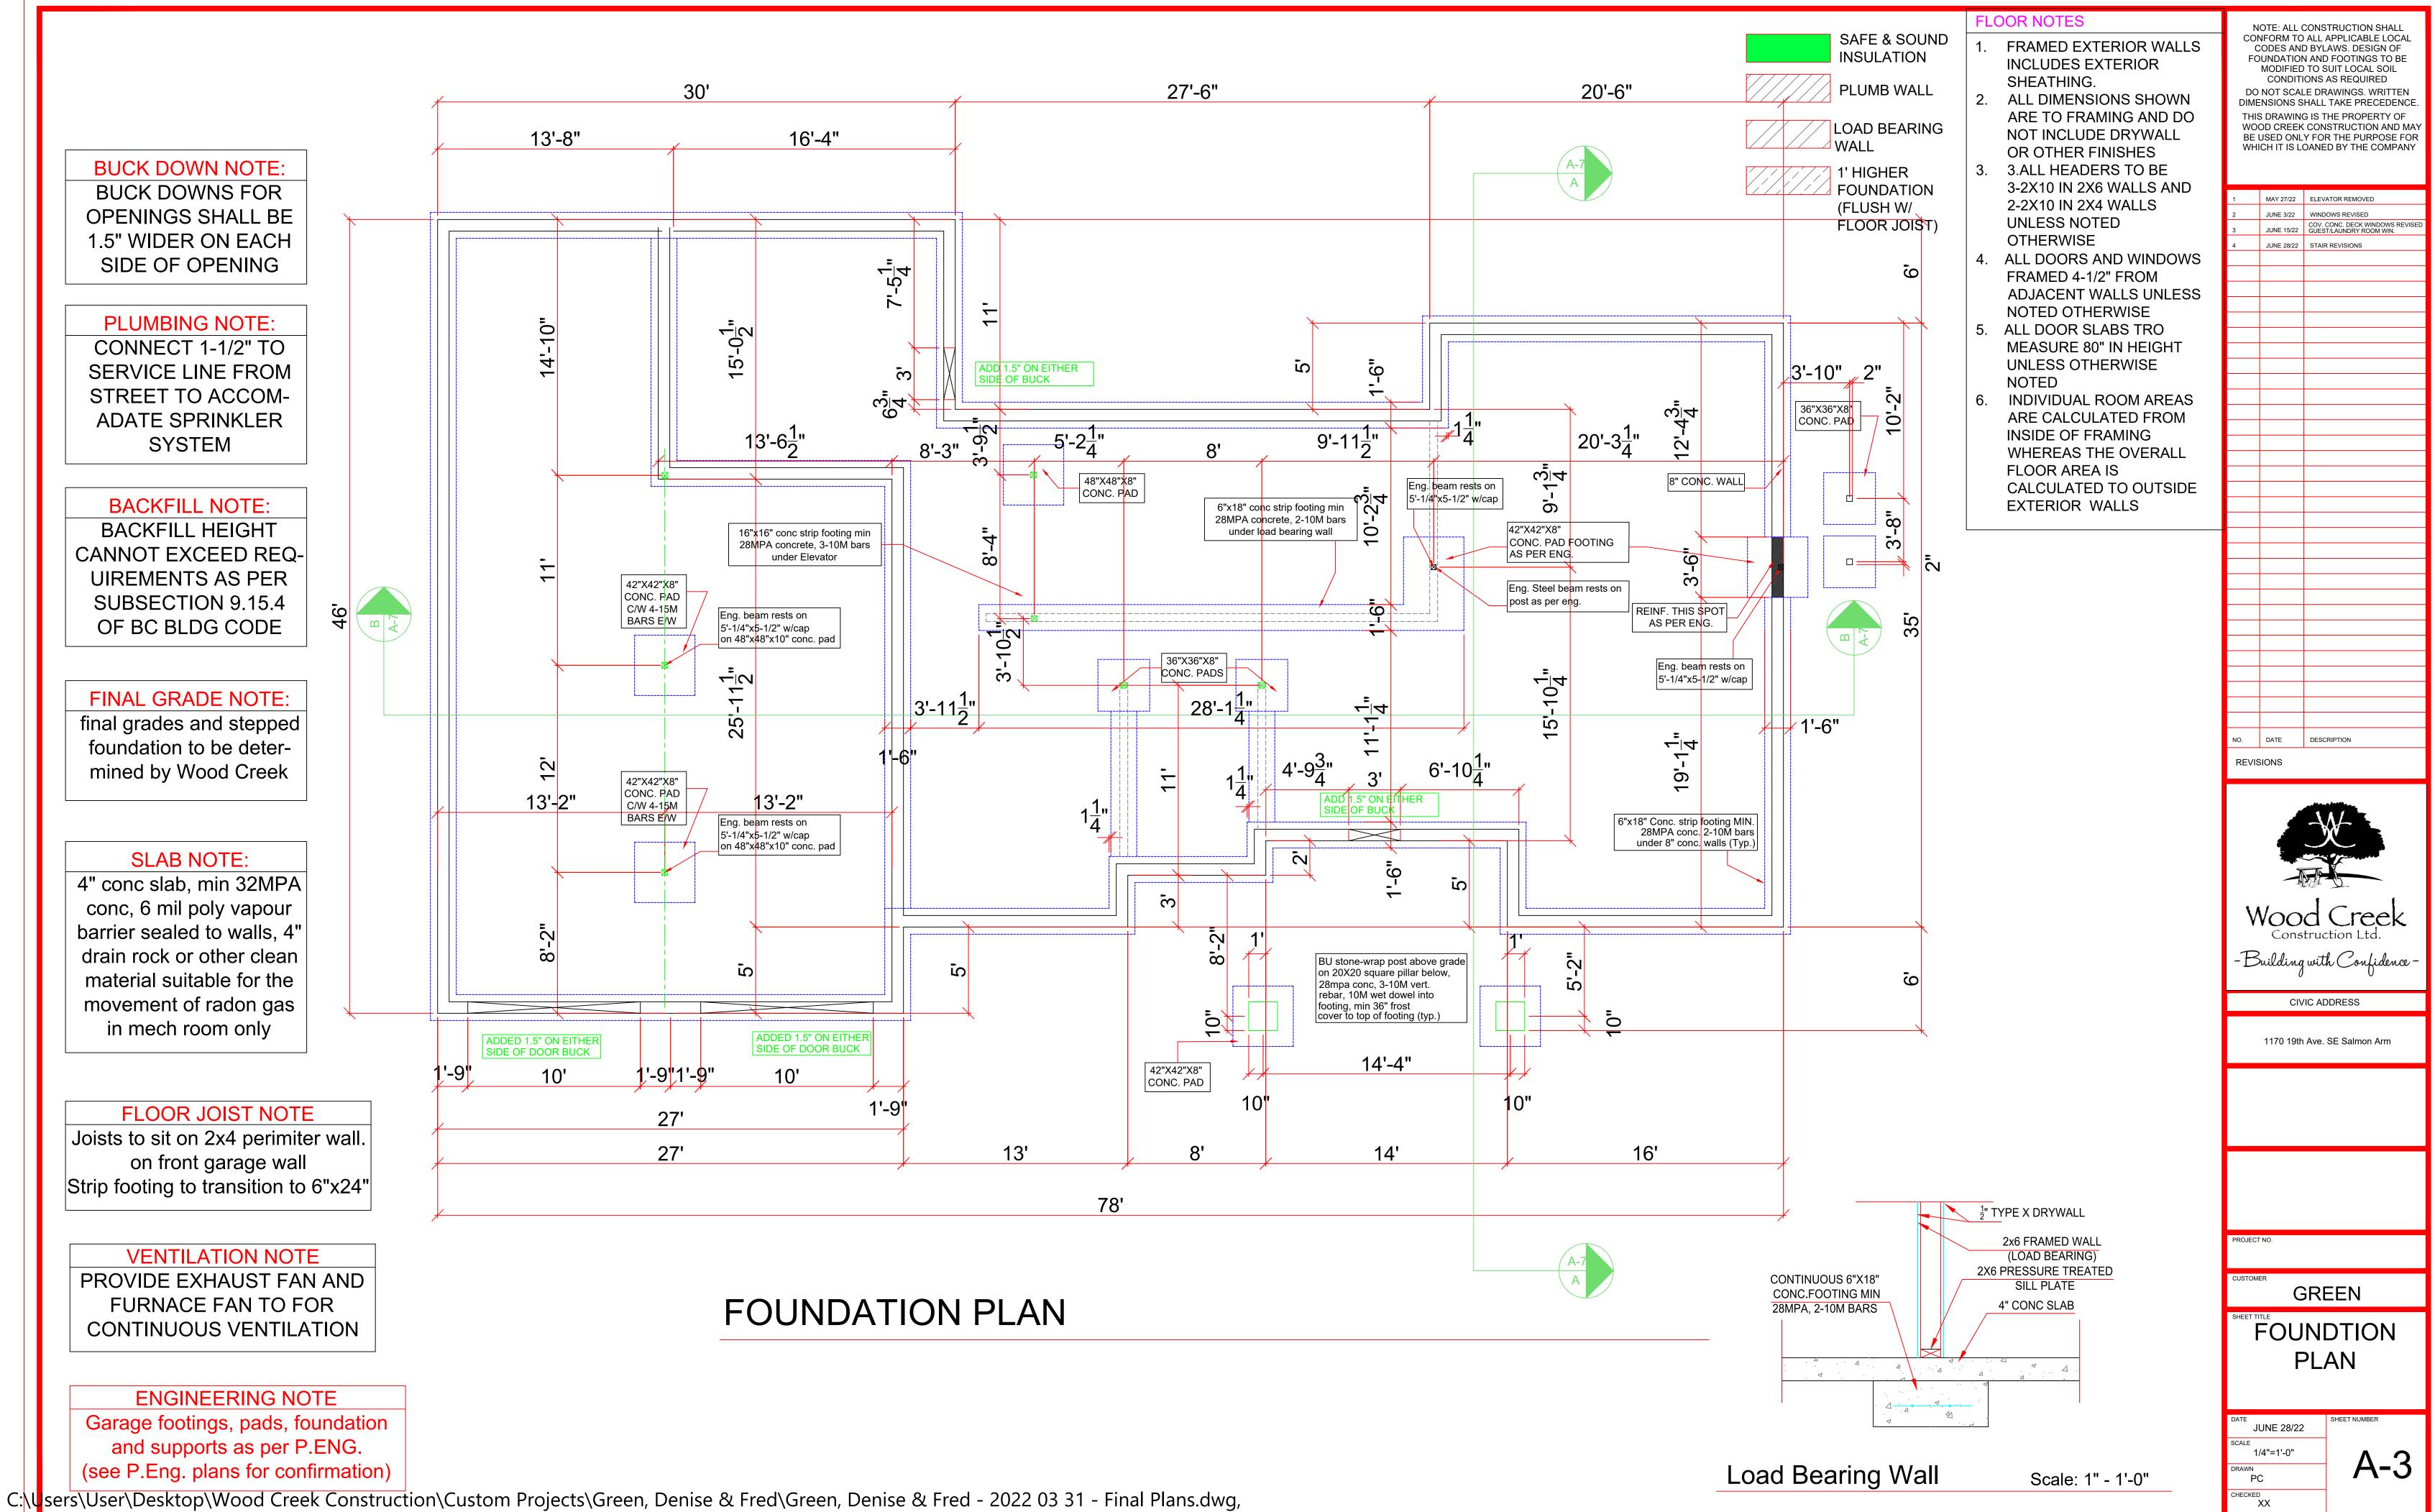

2022-06-28 10:32:17 AM, _AutoCAD PDF (General Documentation).pc3

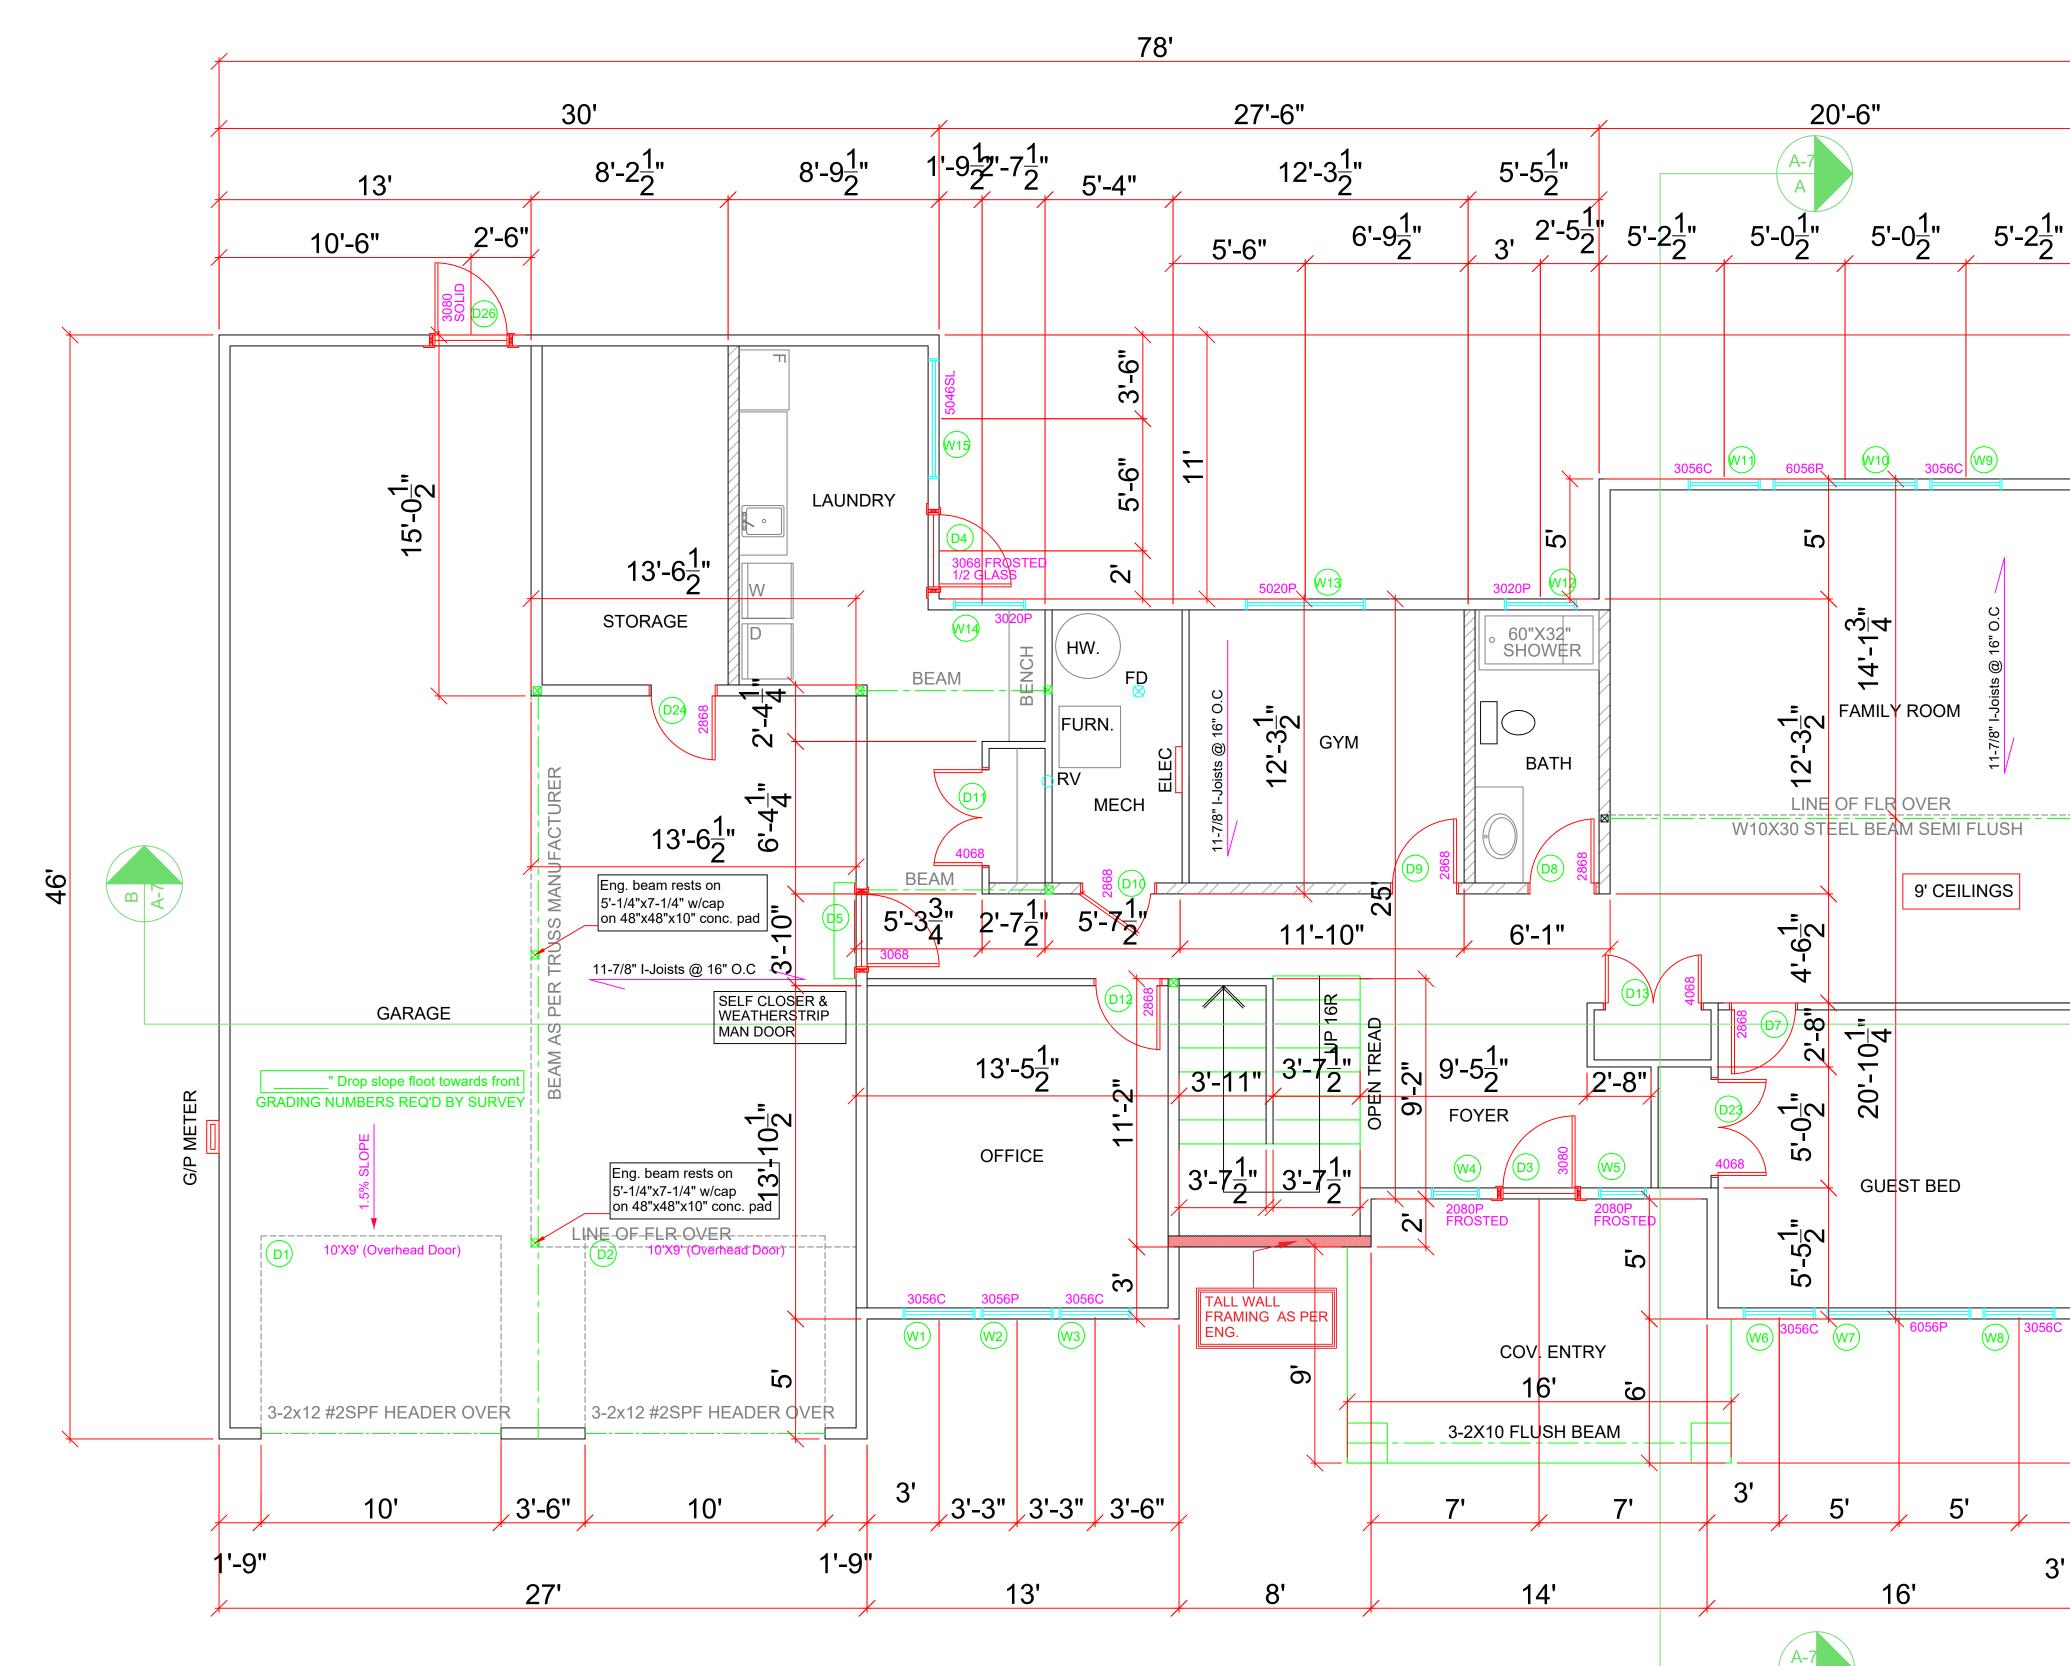



LOWER FLOOR PLAN


1606 SQ. FT. 9' Ceilings

C:\User\User\Desktop\Wood Creek Construction\Custom Projects\Green, Denise & Fred\Green, Denise & Fred - 2022 03 31 - Final Plans.dwg, 2022-06-28 10:32:22 AM, _AutoCAD PDF (General Documentation).pc3

Α

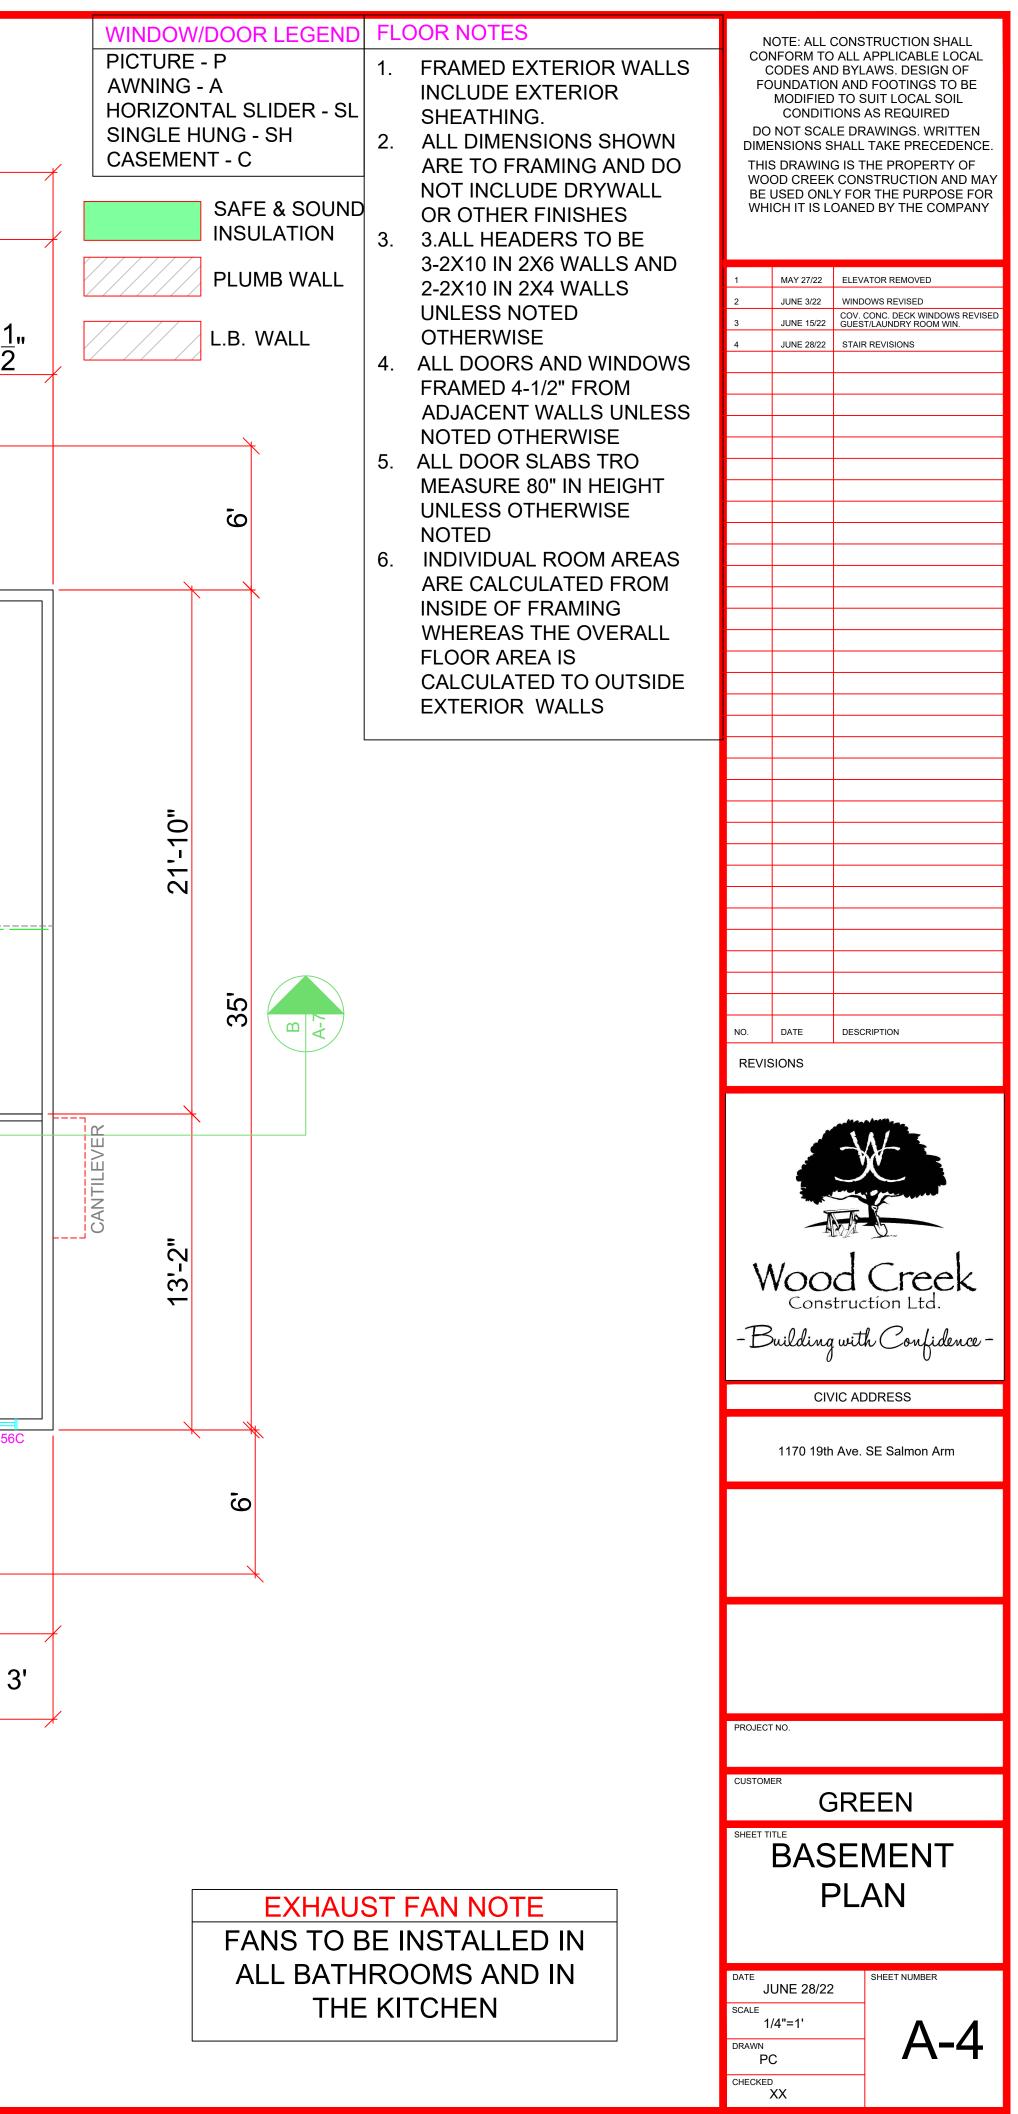


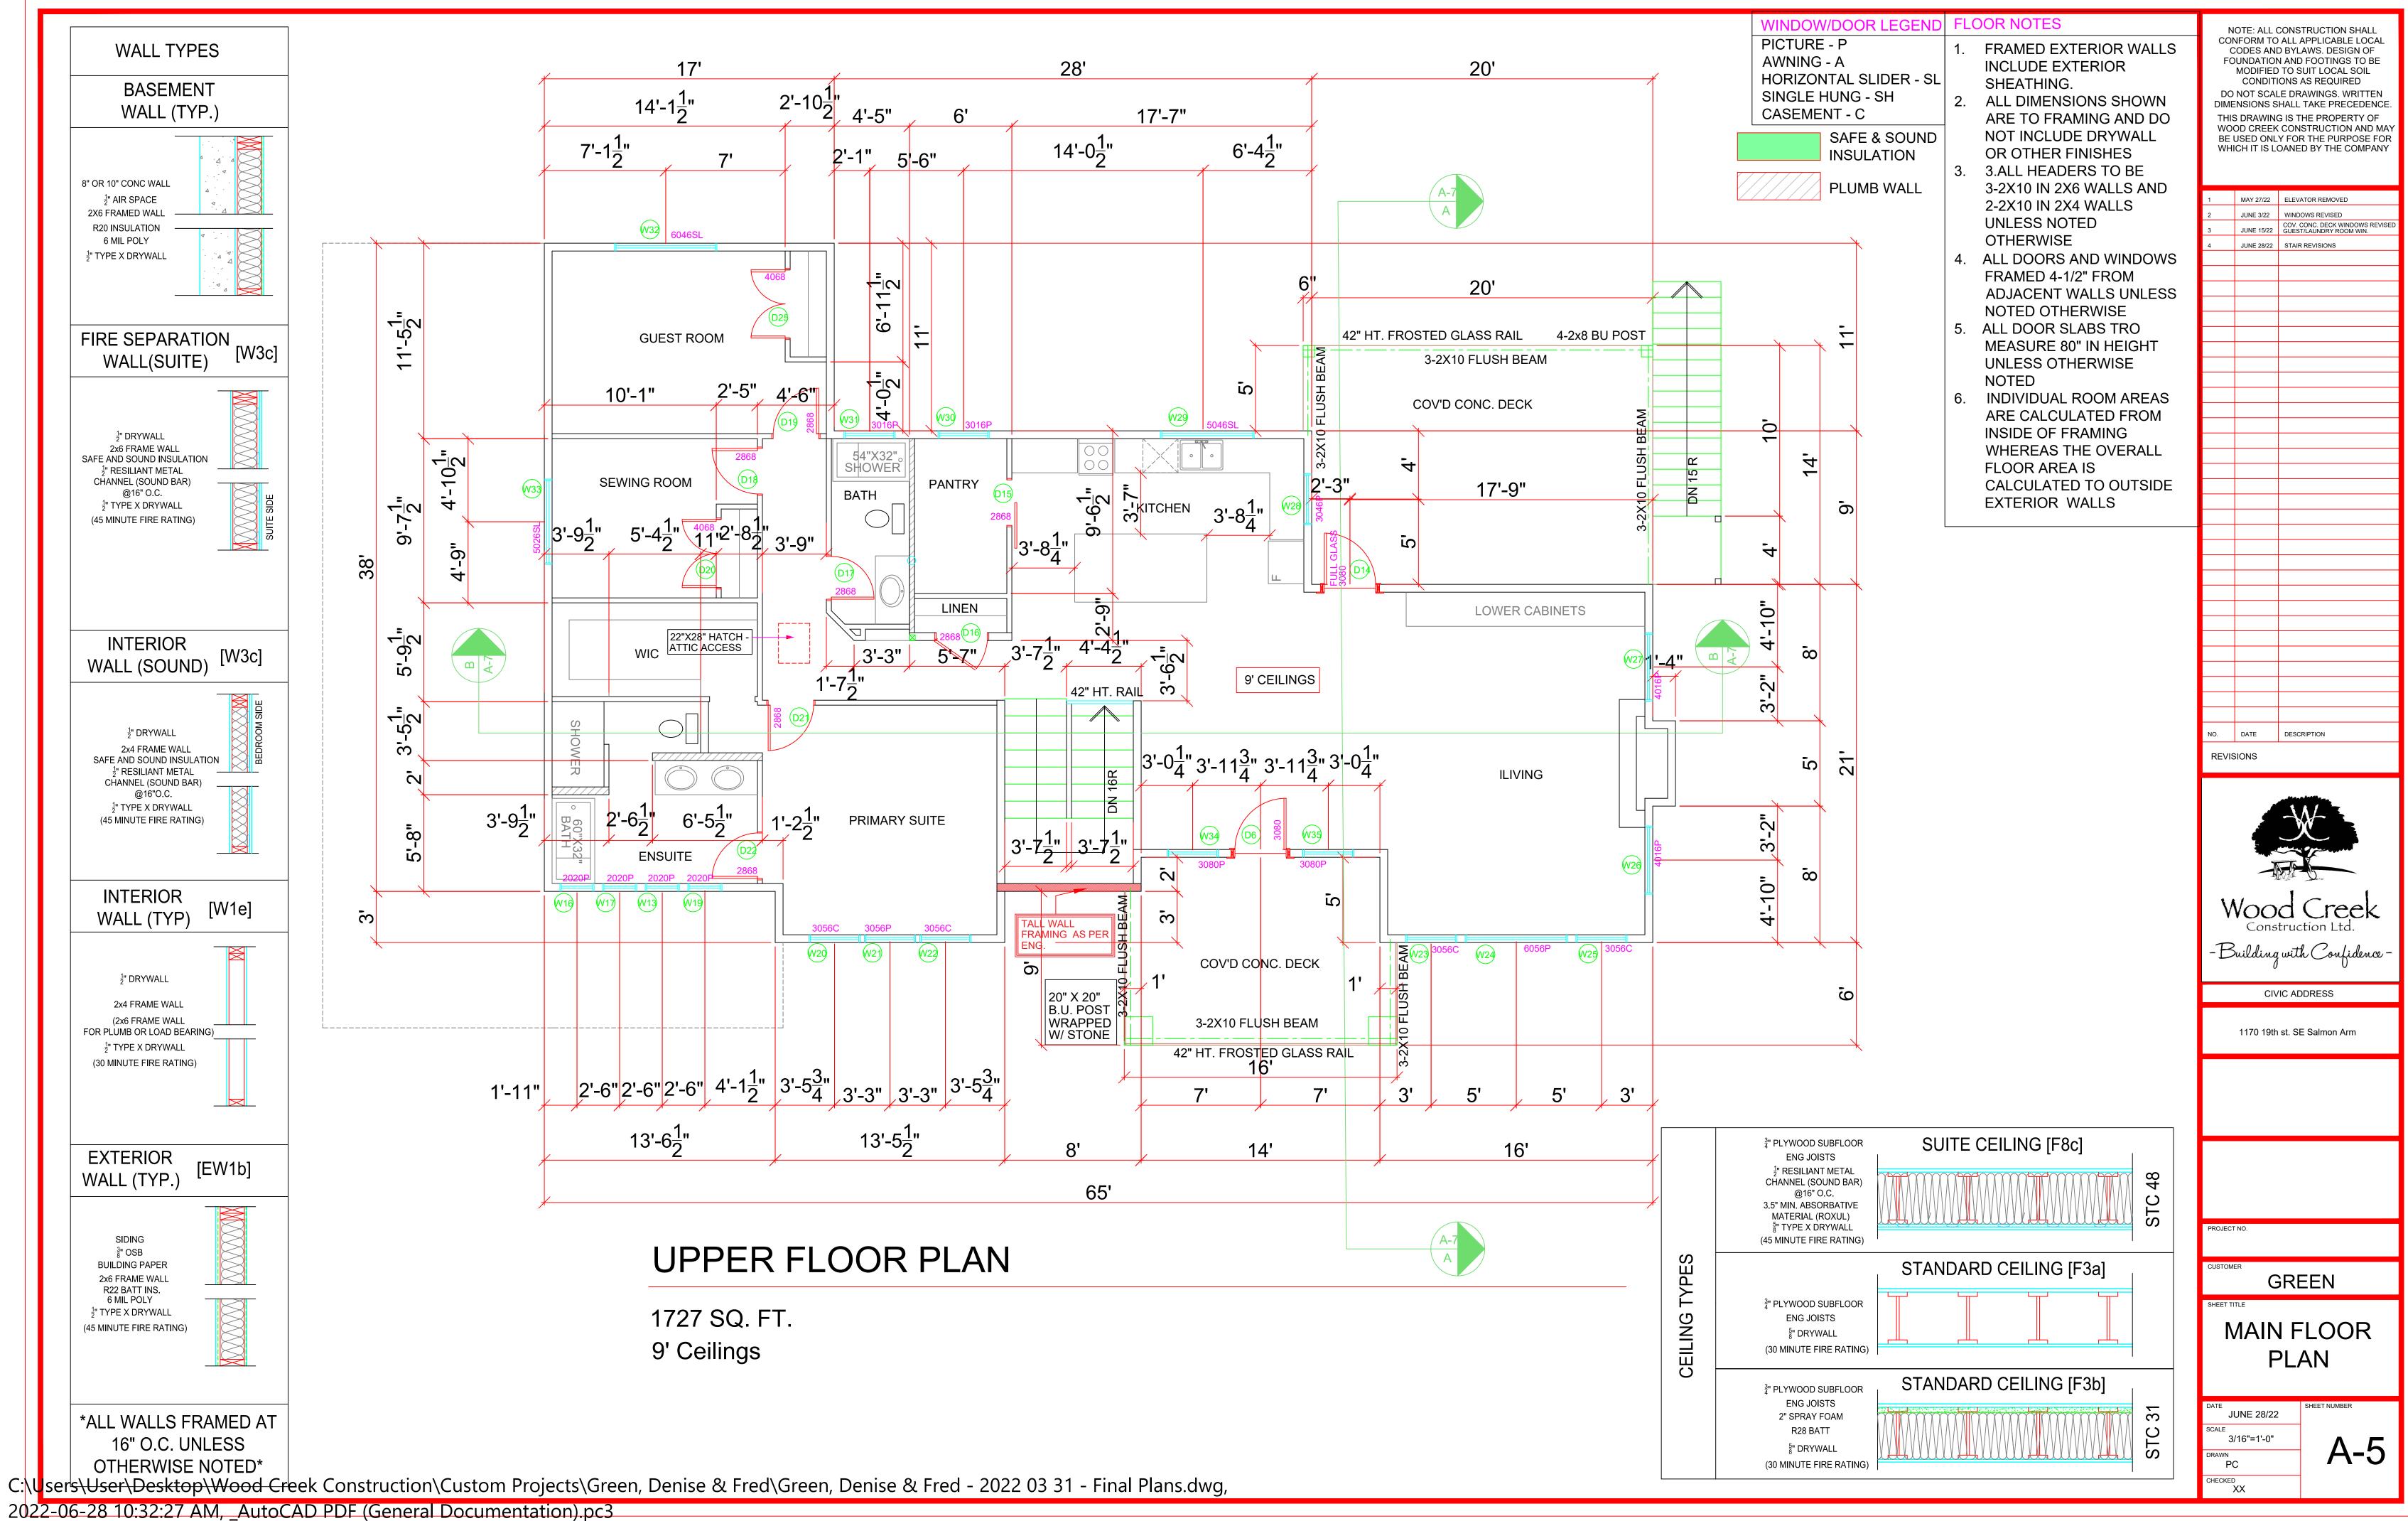


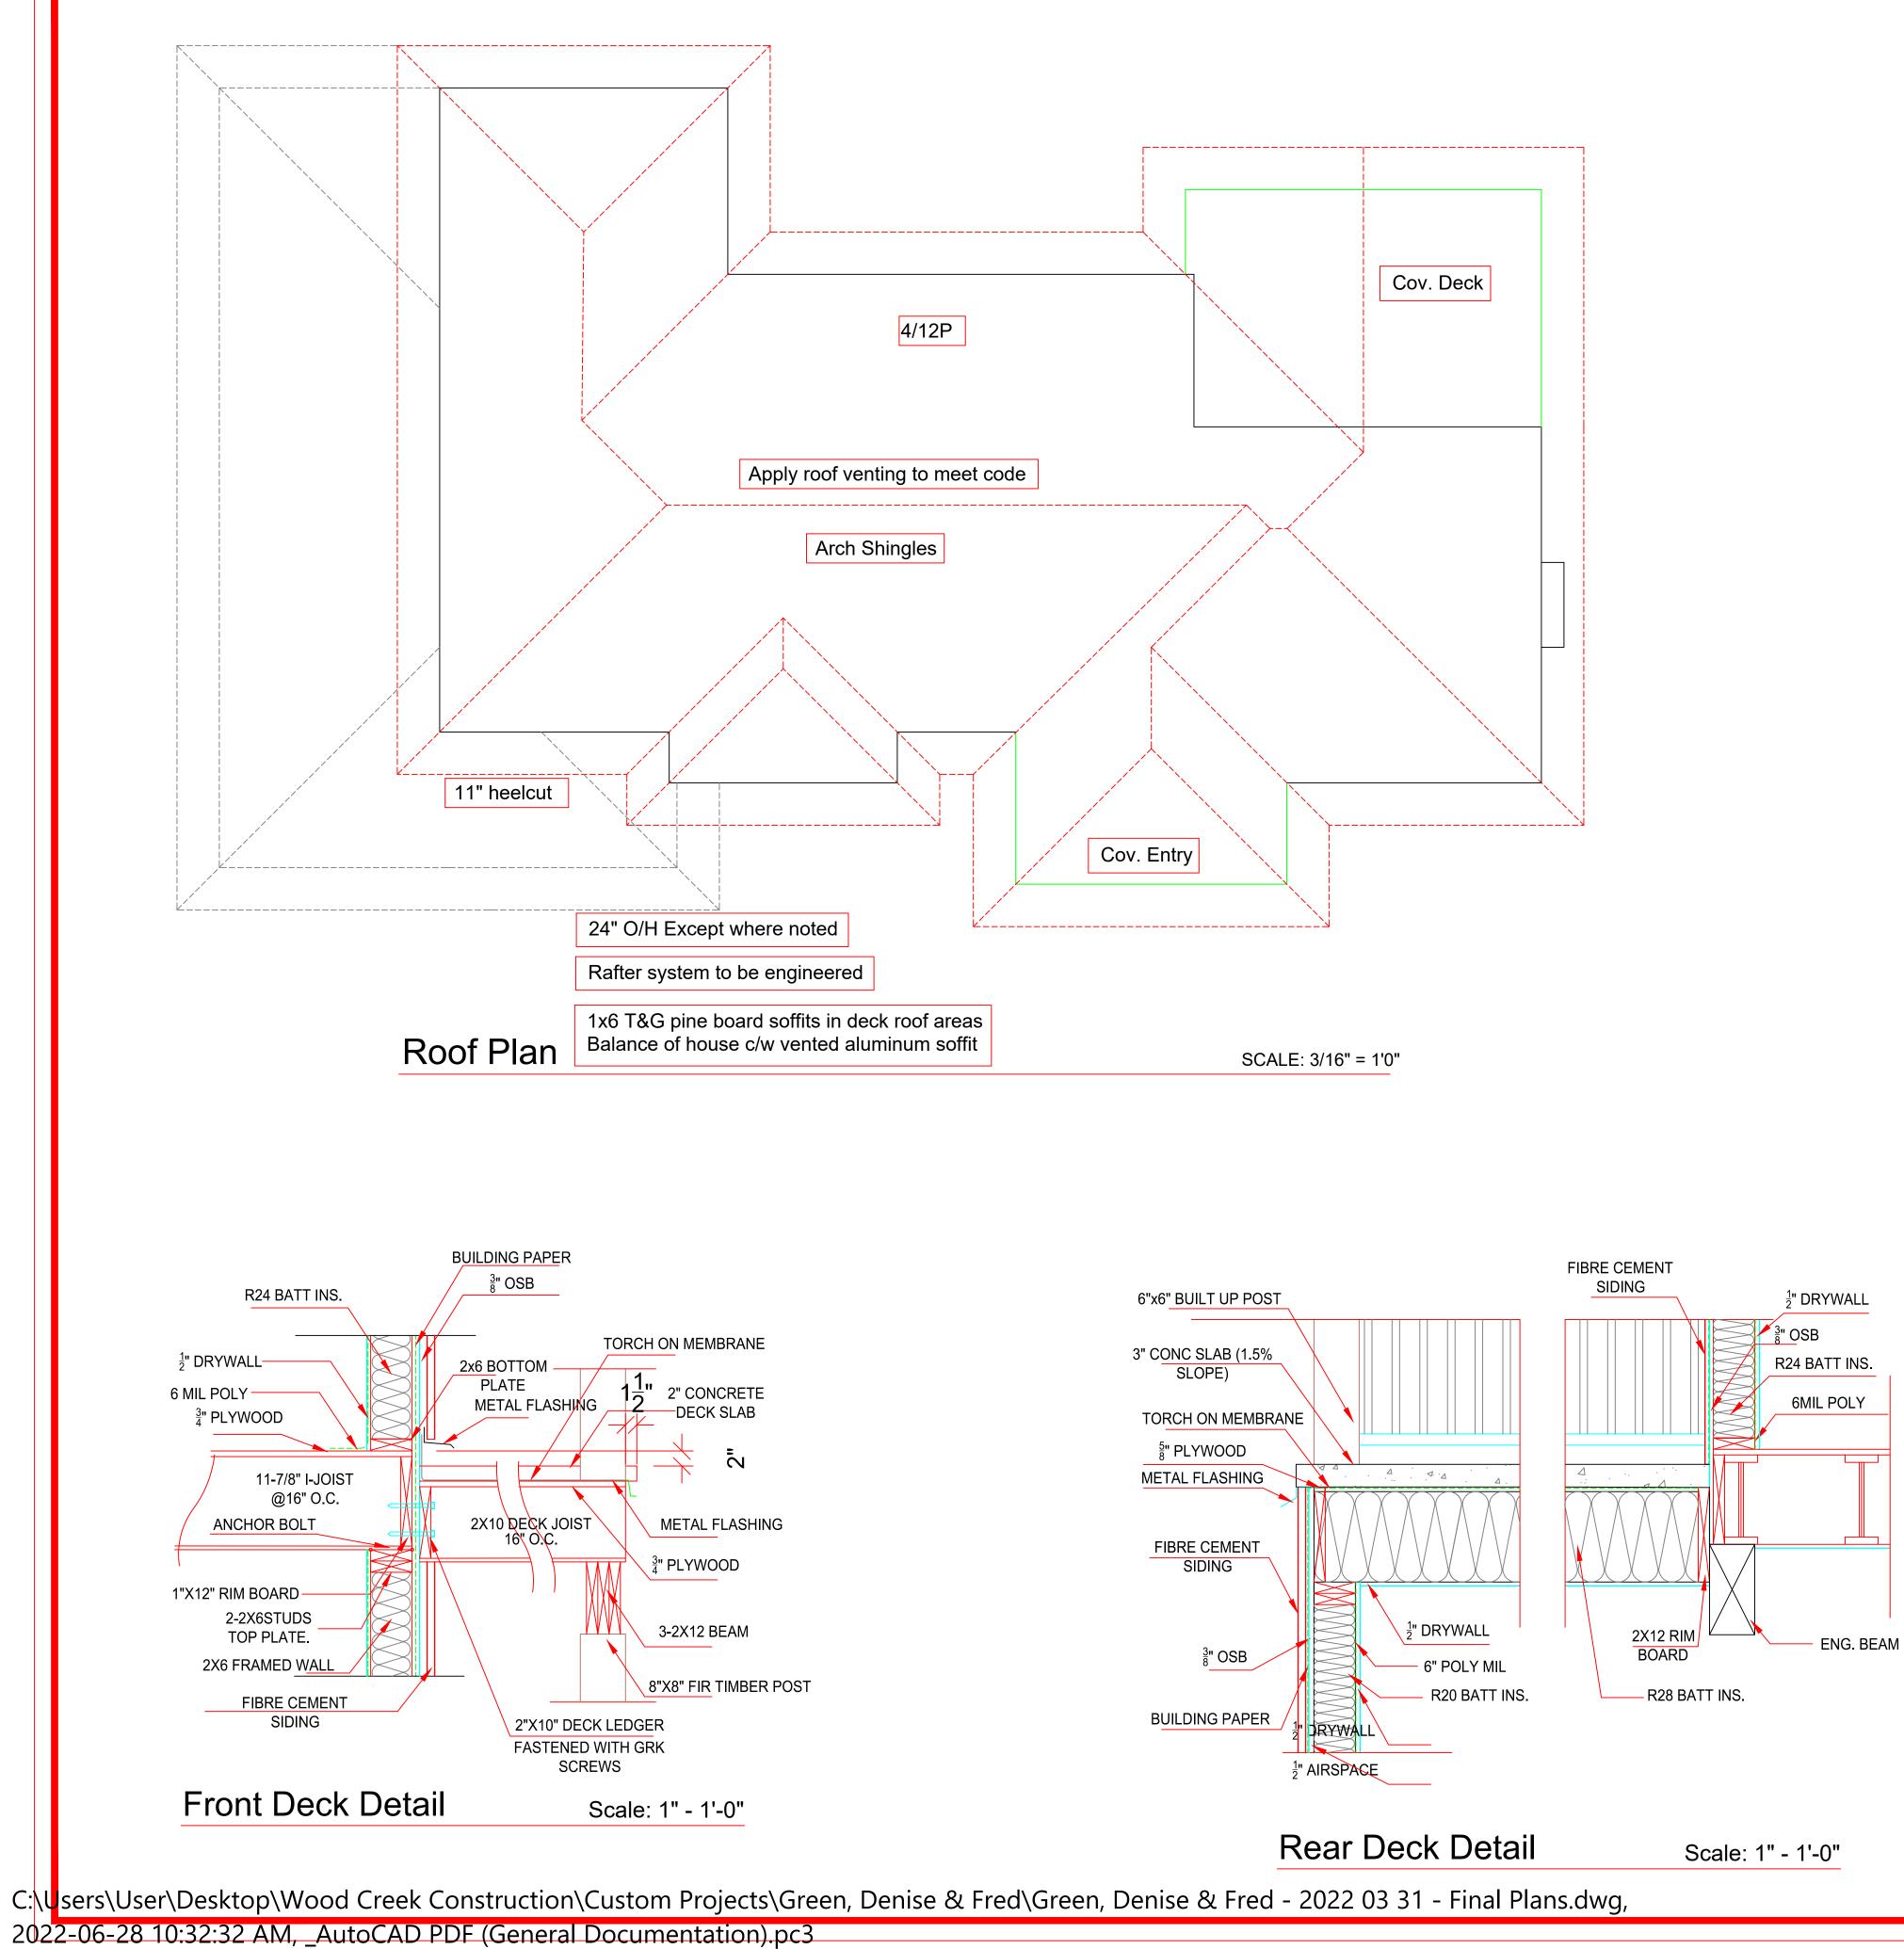

ALUMINUM GUTTER

2x4 FASCIA BOARD METAL FASCIA COVER

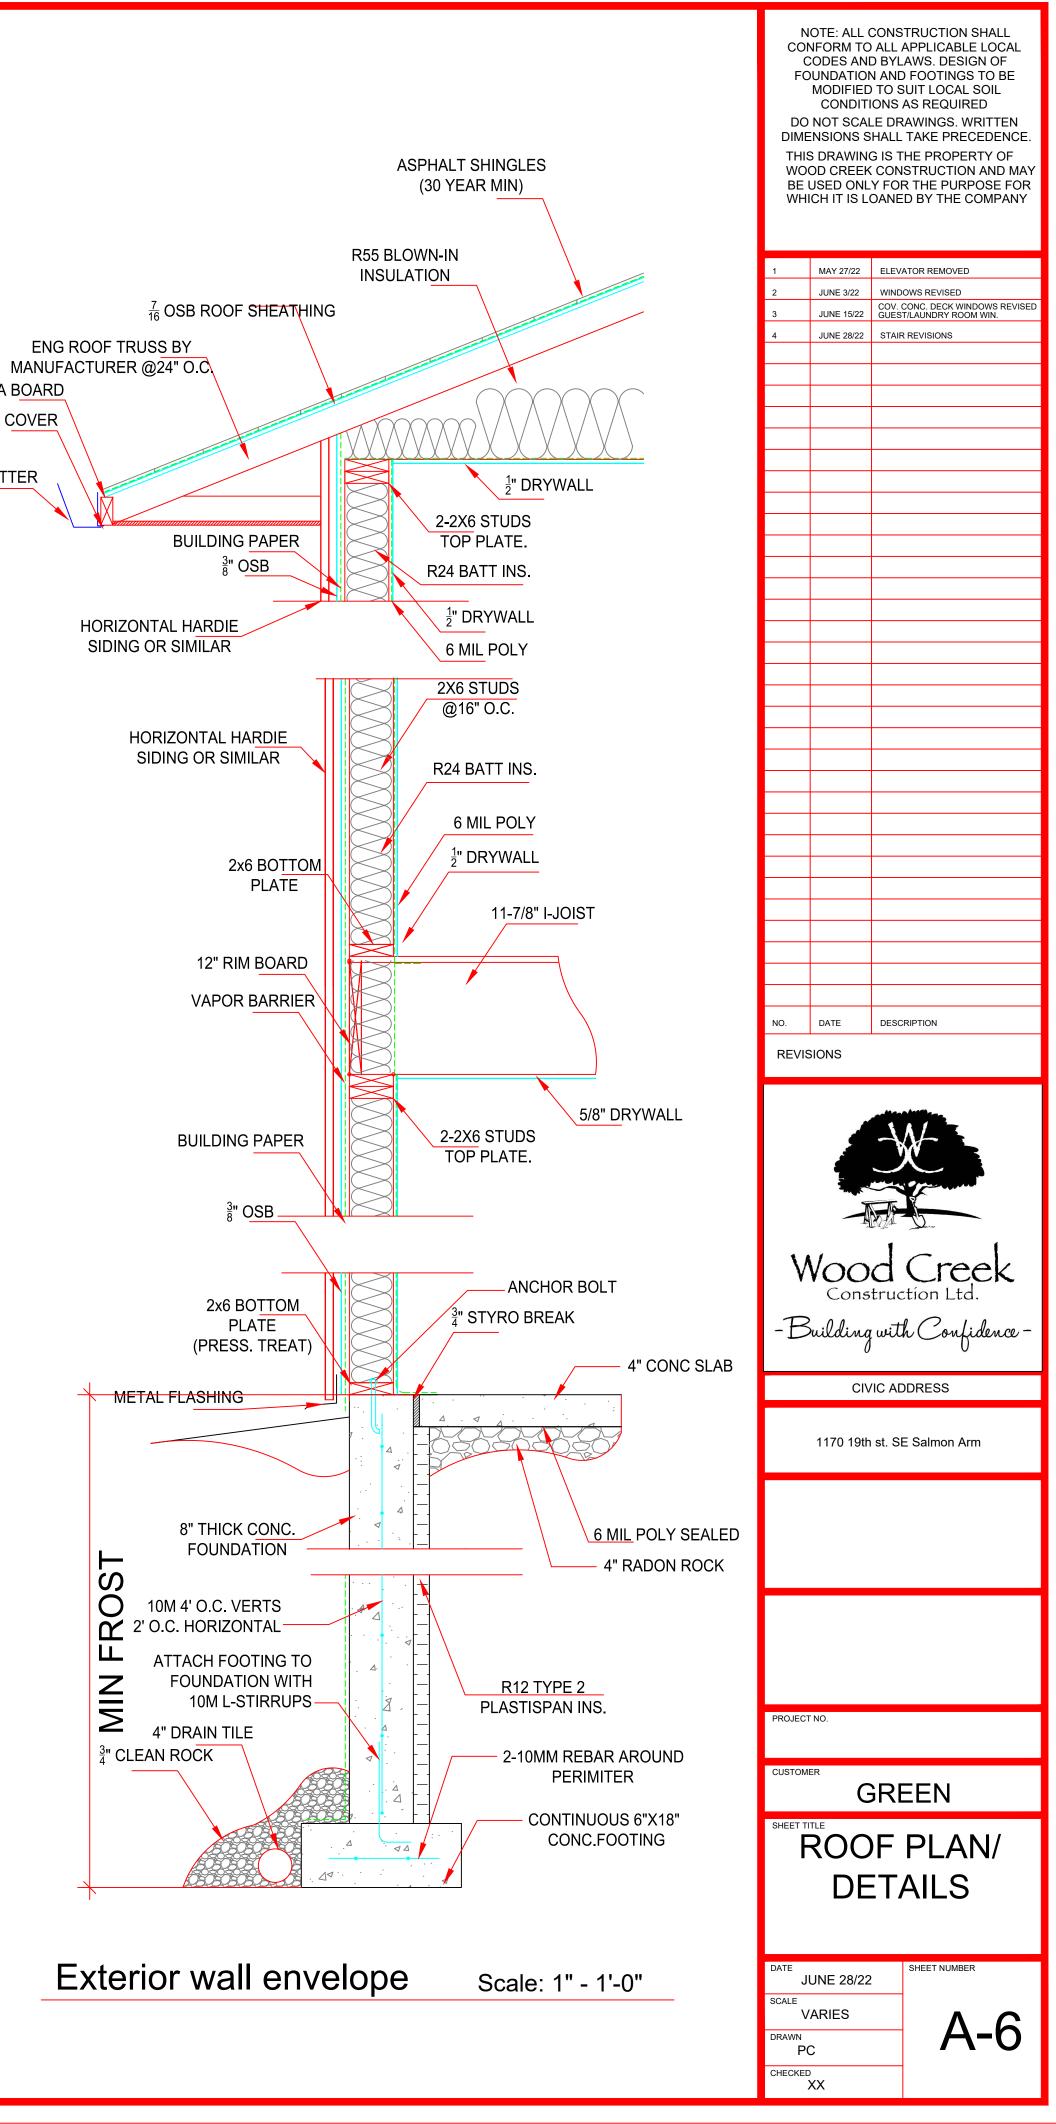

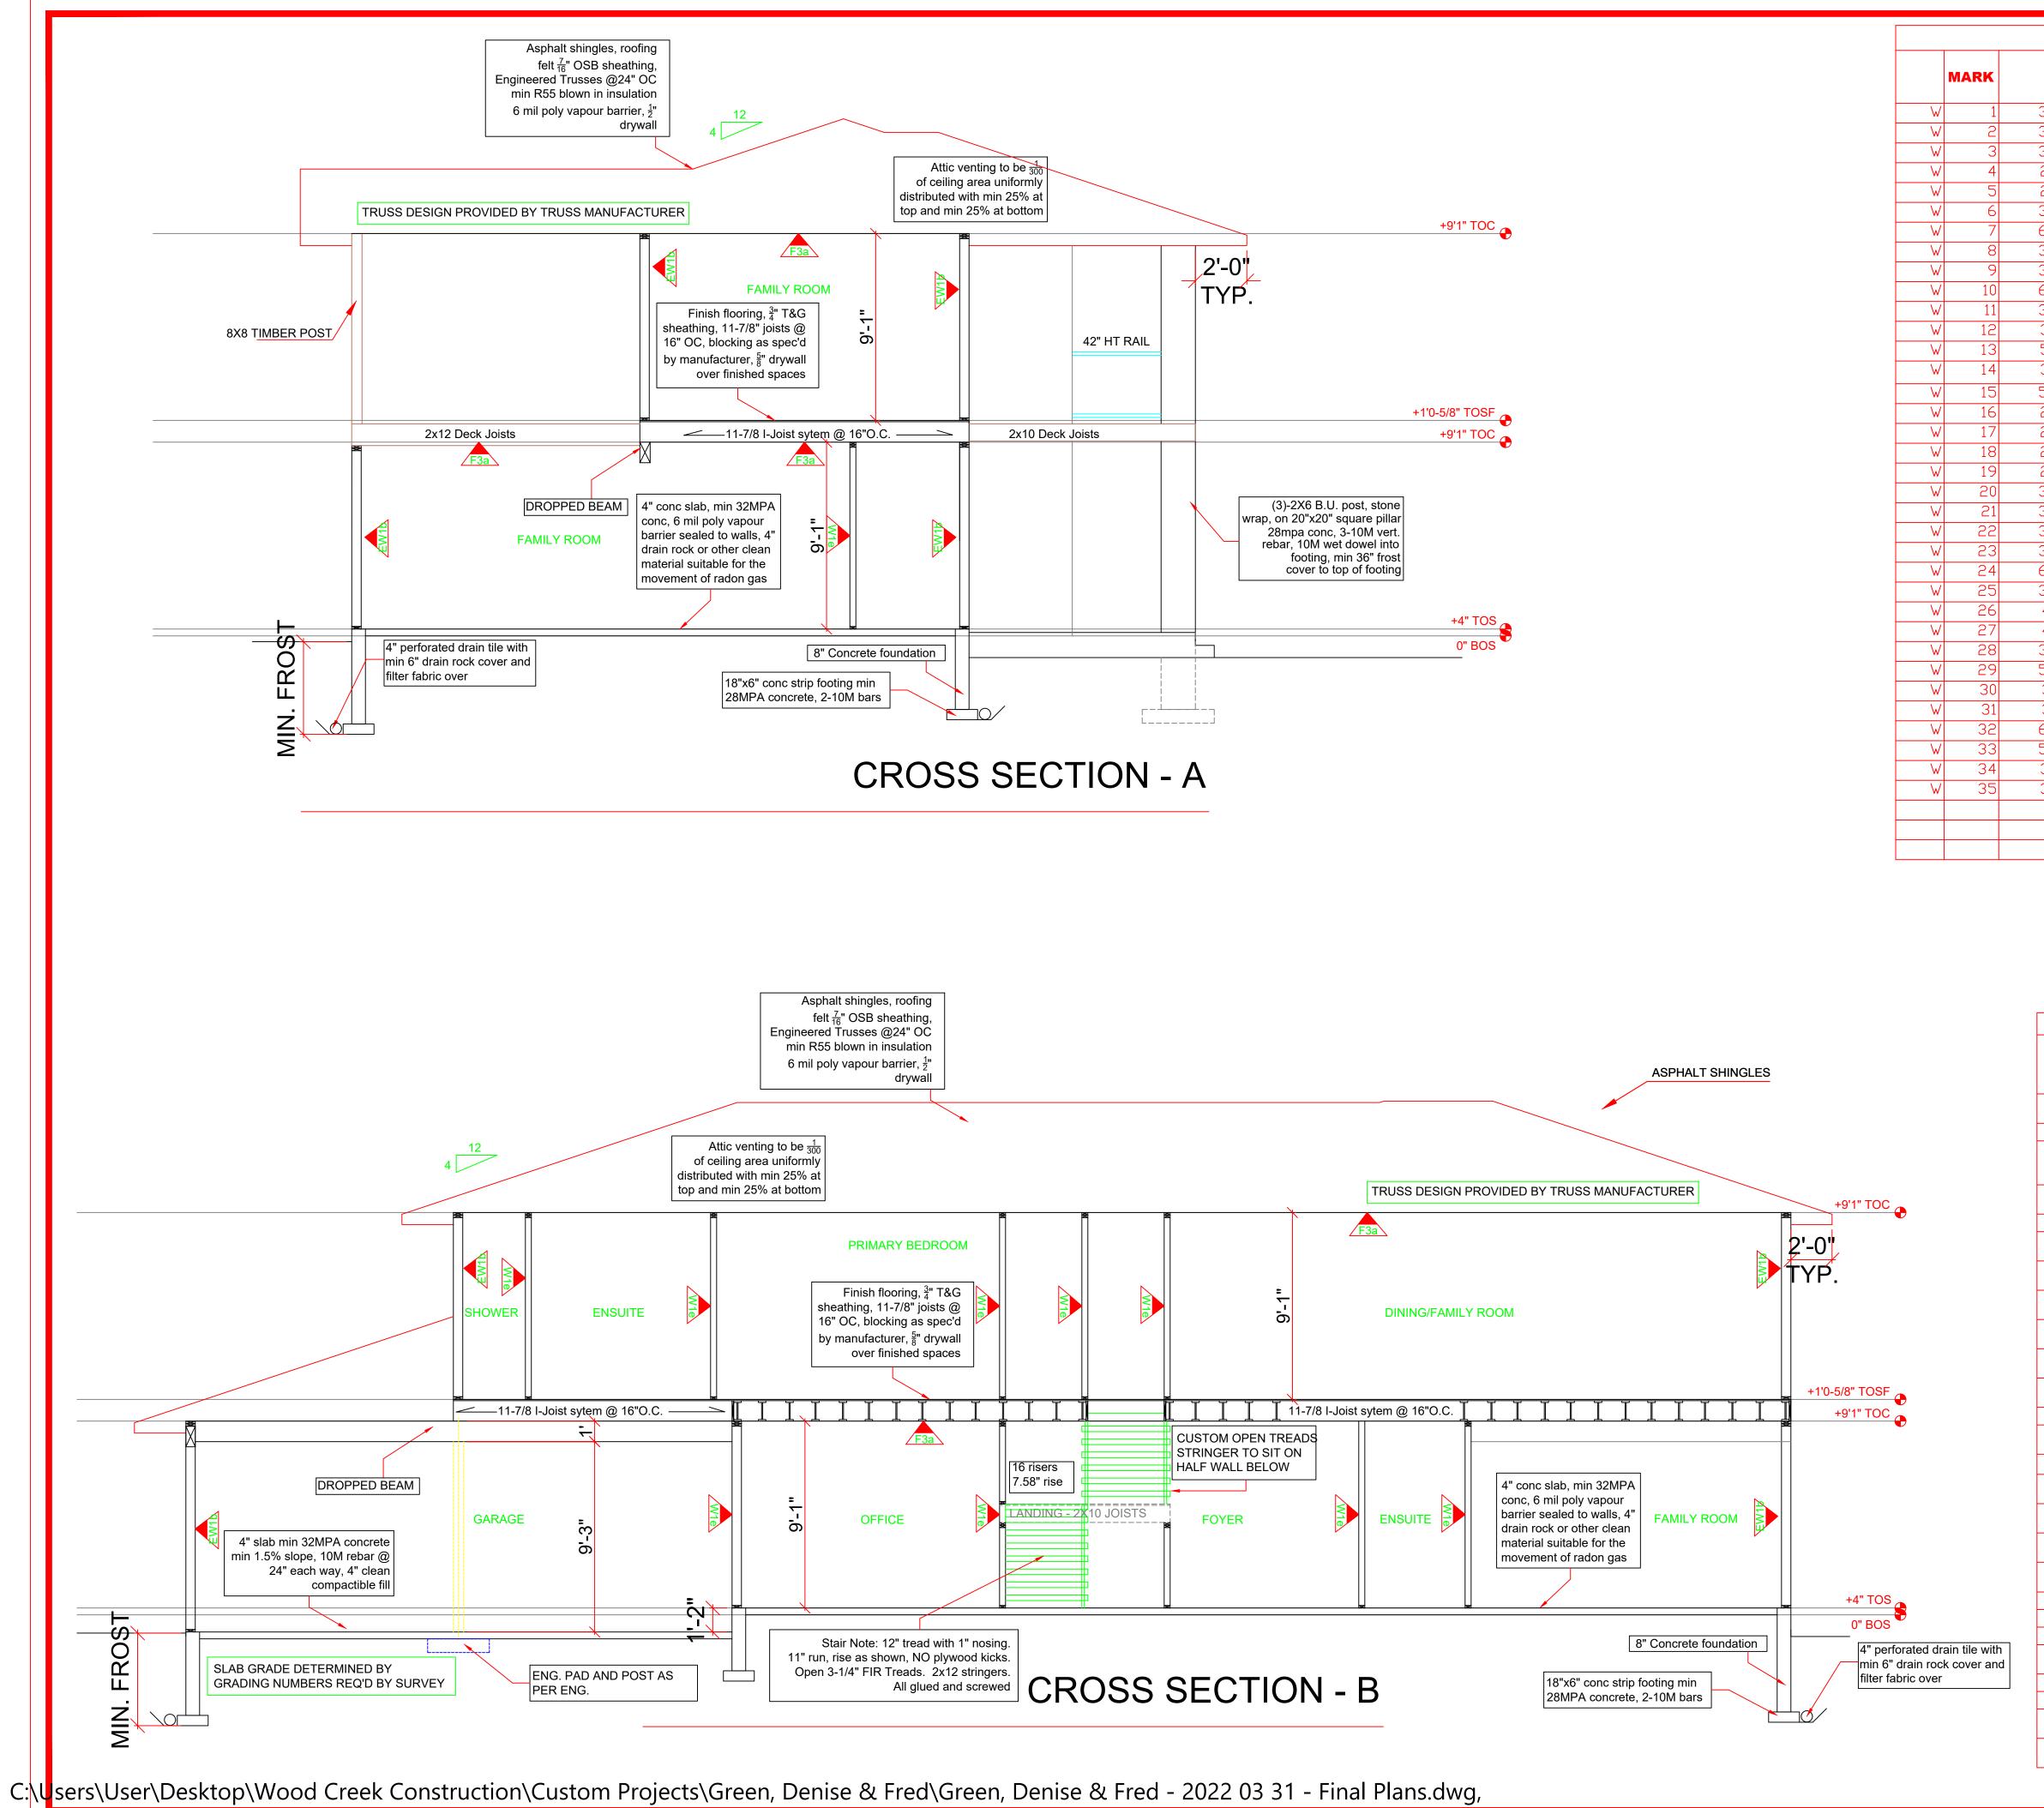

2022-06-28 10:32:37 AM, _AutoCAD PDF (General Documentation).pc3

WINDOW SCHEDULE						
	SASH OPERATION	RO WIDTH [+1/8"]	RO HEIGHT [+1/8"]	COMMENTS		
3056	CASEMENT	3′0″	5′6″			
3056	PICTURE	3′0″	5′6″			
3056	CASEMENT	3′0″	5′6″			
2080	PICTURE	2′0″	8′0″	FROSTED		
2080	PICTURE	2′0″	8′0″	FROSTED		
3056	CASEMENT	3′0″	5′6″			
6056	PICTURE	6′0″	5′6″			
3056	CASEMENT	3′0″	5′6″			
3056	CASEMENT	3′0″	5′6″			
6056	PICTURE	6′0″	5′6″			
3056	CASEMENT	3′0″	5′6″			
3020	PICTURE	3′0″	2′0″			
5020	PICTURE	5′0″	2′0″			
3020	PICTURE	3′0″	2′0″			
5046	SLIDER	5′0″	4′6″			
2020	PICTURE	2′0″	2′0″			
2020	PICTURE	2′0″	2′0″			
2020	PICTURE	2′0″	2′0″			
2020	PICTURE	2′0″	2′0″			
3056	CASEMENT	3′0″	5′6″			
3056	PICTURE	3′0″	5′6″			
3056	CASEMENT	3′0″	5′6″			
3056	CASEMENT	3′0″	5′6″			
5056	PICTURE	6′0″	5′6″			
3056	CASEMENT	3′0″	5′6″			
4016	TRANSOM	4′0″	1′6″			
4016	TRANSOM	4′0″	1′6″			
3046	PICTURE	3′0″	4′6″			
5046	SLIDER	5′0″	4′6″			
3016	TRANSOM	3′0″	1′6″			
3016	TRANSOM	3′0″	1′6″			
5046	SLIDER	6′0″	4′6″			
5026	SLIDER	5′0″	2′6″			
3080	PICTURE	3′0″	8′0″			
3080	PICTURE	3′0″	8′0″			

FO DO DIME THIS WOO BE U	CODES AND BYLAWS. DESIGN OF FOUNDATION AND FOOTINGS TO BE MODIFIED TO SUIT LOCAL SOIL CONDITIONS AS REQUIRED DO NOT SCALE DRAWINGS. WRITTEN DIMENSIONS SHALL TAKE PRECEDENCE. THIS DRAWING IS THE PROPERTY OF WOOD CREEK CONSTRUCTION AND MAY BE USED ONLY FOR THE PURPOSE FOR WHICH IT IS LOANED BY THE COMPANY						
1	1 MAY 27/22 ELEVATOR REMOVED						
2	JUNE 3/22	WINDOWS REVISED					
3	JUNE 15/22	COV. CONC. DECK WINDOWS REVISED GUEST/LAUNDRY ROOM WIN.					
4	JUNE 28/22	STAIR REVISIONS					
-	00.1L 20/22						
NO.	DATE	DESCRIPTION					
REVIS	REVISIONS						

NOTE: ALL CONSTRUCTION SHALL

CONFORM TO ALL APPLICABLE LOCAL CODES AND BYLAWS. DESIGN OF



WOOD Creek Construction Ltd.	
-Building with Confidence -	_

0

1170 19th st. SE Salmon Arm

CIVIC ADDRESS

PROJECT NO. CUSTOMER GREEN SHEET TITLE SECTIONS

SHEET NUMBER JUNE 28/22 3/16"=1' A-7 CHECKED XX

DATE

SCALE

					_	
MARK		DOOR OPERATION	RO WIDTH [+2"]	RO HEIGHT	SIDE LITES	LOCATION
1	10090	DVERHEAD				GARAGE
2	10090	DVERHEAD				GARAGE
3	3080	SWING SIMPLE				FRONT ENTRY
4	3080	SWING SIMPLE				REAR PATIO
5	3080	SWING SIMPLE				GARAGE
6	3080	SWING SIMPLE				COV, DECK
7	2868	SWING SIMPLE				GUEST BED
8	2868	SWING SIMPLE				BATH
9	2868	SWING SIMPLE				GYM
10	2868	SWING SIMPLE				LOWER ELEVATOR
11	4068	SWING SIMPLE				CLOSET
12	2868	SWING SIMPLE				DFFICE
13	4068	SWING BI-PART				ENTRY CLOSET
14	3080	SWING SIMPLE				REAR DECK
15	2868	BARN STYLE				PANTRY
16	2868	SWING SIMPLE				UPPER ELEVATOR
17	2868	SWING SIMPLE				BATH
18	2868	SWING SIMPLE				SWEING ROOM
19	2868	SWING SIMPLE				GUEST ROOM
20	4068	SWING BI-PART				SWEING CLOSET
21	2868	SWING SIMPLE				PRIMARY
22	2868	SWING SIMPLE				ENSUITE
23	4068	SWING BI-PART				GUEST BED
24	2868	SWING SIMPLE				STORAGE
25	4068	SWING BI-PART				GUEST CLOSET
26	3068	SWING SIMPLE				REAR GARAGE ENTRY MAN DOOR
	1 2 3 3 4 4 5 6 7 8 7 7 8 7 7 8 7 7 10 11 10 11 10 11 12 10 11 12 10 11 12 10 11 12 10 11 12 10 11 12 10 11 12 10 11 12 10 11 12 10 11 11 12 10 11 11 12 10 11 11 12 11 11 12 11 11 12 11 11 12 11 11	1 10090 2 10090 3 3080 3 3080 4 3080 5 3080 6 3080 6 3080 6 3080 6 3080 6 3080 6 3080 7 2868 10 2868 11 4068 12 2868 13 4068 14 3080 15 2868 13 4068 14 3080 15 2868 16 2868 17 2868 18 2868 20 4068 21 2868 22 2868 23 4068 24 2868 25 4068	MARK OPERATION 1 10090 UVERHEAD 2 10090 UVERHEAD 3 3080 SWING SIMPLE 3 3080 SWING SIMPLE 4 3080 SWING SIMPLE 5 3080 SWING SIMPLE 6 3080 SWING SIMPLE 7 2868 SWING SIMPLE 8 2868 SWING SIMPLE 9 2868 SWING SIMPLE 10 2868 SWING SIMPLE 11 4068 SWING SIMPLE 12 2868 SWING SIMPLE 13 4068 SWING SIMPLE 14 3080 SWING SIMPLE 15 2868 SWING SIMPLE 16 2868 SWING SIMPLE 17 2868 SWING SIMPLE 18 2868 SWING SIMPLE 19 2868 SWING SIMPLE 20 4068 SWING SIMPLE 21 2868 SWING SIMPLE	MARK OPERATION [+2"] 1 10090 UVERHEAD	MARK OPERATION [+2"] HEIGHT 1 10090 UVERHEAD - 2 10090 UVERHEAD - 3 3080 SWING SIMPLE - 4 3080 SWING SIMPLE - 5 3080 SWING SIMPLE - 6 3080 SWING SIMPLE - 7 2868 SWING SIMPLE - 9 2868 SWING SIMPLE - 9 2868 SWING SIMPLE - 10 2868 SWING SIMPLE - 11 4068 SWING SIMPLE - 12 2868 SWING SIMPLE - 13 4068 SWING SIMPLE - 14 3080 SWING SIMPLE - 15 2868 BARN STYLE - 16 2868 SWING SIMPLE - 17 2868 SWING SIMPLE - 18 2868 SWING SIMPLE<	MARKOPERATION[+2"]HEIGHTLITES110090UVERHEAD </td

DOOR SCHEDULE